## <u>ADDRESS - ACCESSORY DWELLING UNIT</u>

PROFESSIONALS		CODE COMPLIANCE	_			
DESIGNER  ADAM STICKELS CONTRACTOR 1263 MEAD VENTURA 805-616-0664	OWNER N/A	ALL WORK AND MATERIALS SHALL BE PERFORMED AND INSTALLED IN COMPLIANCE WITH THE CURRENT EDITIONS OF THE FOLLOWING CODES AS ADOPTED BY THE LOCAL GOVERNING AUTHORITIES. NOTHING IN THESE PLANS IS TO BE CONSTRUED TO PERMIT WORK NOT CONFORMING TO THESE CODES.  COUNTY AIR POLLUTION CONTROL DISTRICT REQUIREMENTS. 2023 CALIFORNIA BUILDING ADMINISTRATIVE CODE, PART 1 2023 CALIFORNIA BUILDING CODE, PART 2 2023 CALIFORNIA RESIDENTIAL CODE, PART 2.5 2023 CALIFORNIA ELECTRICAL CODE, PART 3				
STRUCTURAL ENGINEER TBD	ARBORIST N/A	2023 CALIFORNIA MECHANICAL CODE, PART 4 2023 CALIFORNIA PLUMBING CODE, PART 5 2023 CALIFORNIA ENERGY CODE, PART 6 2023 CALIFORNIA FIRE CODE, PART 9 2023 CALIFORNIA GREEN BUILDING STANDARDS CODE, PART 11 2023 CALIFORNIA REFERENCED STANDARDS CODE, PART 12 2023 CALIFORNIA CODE, TITLE 24 CD-ROM 2023 CALIFORNIA TITLE 24 COMPLETE COLLECTION NATIONAL ELECTRIC CODE FEDERAL - OSHA SANTA BARBARA COUNTY (SBCO) BUILDING ORDINANCE #5092 SBCO GRADING ORDINANCE #4766.				
CIVIL ENGINEER	SOILS ENGINEER					
PERVIOUS/ IMPERVIOUS AREAS		SHEET INDEX	PROJECT INFO			PROJECT DESCRIPTION
EXISTING:  IMPERVIOUS ROOF AREA: IMPERVIOUS PAVING AREA: PERMEABLE PAVING: LANDSCAPE/ PERVIOUS:	0 SF (0%) 0 SF (0%) 0 SF (0%) 0 SF (0%)	# 出	PROJECT ADDRESS:  A.P.N. :  CONSTRUCTION TYPE:	ADDRESS 000-000-000 N/A 0 ACRES		NEW PROPOSED ADU BUILDING NET 800 SQFT. TWO BEDROOM WITH FIREPLACE AND REAR FACING PATIO SPACE.
PROPOSED:	<b>,</b> ,	T-1.0A COVER SHEET T-1.3 SITE PHOTOS T-1.4 AREA PLANS	LOT ACREAGE:  ZONING:	0 ACRES 0 SQ FT ZONE: ZON	E	CONSTRUCTION WASTE MANAGEMENT:
MPERVIOUS ROOF AREA: MPERVIOUS PAVING AREA:	0 SF (0%)	T-1.5 SPANISH MATERIALS BOARD	HIGH FIRE HAZARD AREA:	N/A		COUNTY APPROVED WASTE MANAGEMENT COMPANY IS TO BE MARBORG INDUSTRIES, 136 N QUARANTINA ST, SANTA BARBARA, CA, 93103. PHONE 805.963.1852
PERVIOUS PAVING AREA: ERMEABLE PAVING: ANDSCAPE/ PERVIOUS:	0 SF (0%) 0 SF (0%) 0 SF (0%)	ARCHITECTURAL  A-1.1 SITE PLAN  A-2.10 EXISTING RESIDENCE FLOOR PLAN	OCCUPANCY:	RESIDENTI	AL	CONSTRUCTION WASTE REDUCTION TO COMPLY WITH DISPOSAL AND RECYCLING PROVISIONS OF THE CALIFORNIA GREEN BUILDING STANDARDS CODE SECTION 4.408.1
		A-2.11 PROPOSED SPANISH FLOOR PLANS A-2.14 LEVEL 1 REFLECTED CEILING PLAN	STORIES:  FIRE SPRINKLERS:	NO		
PECIAL INSPECT	TIONS	A-2.15 3D VIEW OF ADU  A-4.1 ROOF PLAN  A-5.1 BUILDING SECTIONS  A-6.1 PROPOSED EXTERIOR WITH CHIMNEY ELEVATIONS  A-6.2 PROPOSED EXTERIOR WITHOUT CHIMNEY ELEVATIONS  A-9.1 DETAILS	SLOPE:	0%		
), SEE STRUCTURAL		A-9.2 DETAILS	AREA BREAKDOWN - PLANNING		1	
			EXISTING:  EXISTING RESIDENCE:	NET 0 SQFT	GROSS 0 SQFT	VICINITY MAP
			TOTAL EXISTING:	0 SQFT	0 SQFT	NOT TO SCALE
			TOTAL EXISTING.	0 0 0 0 1	0 0 0 1	
			PROPOSED DETACHED ADU:	800 SQFT	876 SQFT	
			TOTAL PROPOSED:	800 SQFT	876 SQFT	
RE DEPARTMEN	IT NOTES:		TOTAL DEVELOPMENT:	0 SQFT	0 SQFT	
NO FIRE SPRINKLERS						1
			FLOOR AREA. AS USED IN THIS SECTION 35-142 (ACCESSOR'D DWELLING UNITS), "FLOOR AREA" MEANS THE FLOOR AREA' WALLS OF THE BUILDING UNDER CONSIDERATION, EXCLUSIVE DEDUCTION FOR CORRIDORS, STAIRWAYS, RAMPS, CLOSET OR OTHER FEATURES.  THE FLOOR AREA OF A BUILDING, OR PORTION THEREOF, NO WALLS SHALL BE THE USEABLE AREA UNDER THE HORIZON'THE GROSS FLOOR AREA SHALL NOT INCLUDE SHAFTS WITH	WITHIN THE INSIDE PERIME' /E OF VENT SHAFTS AND CO S, THE THICKNESS OF INTEI  OT PROVIDED WITH SURROUTE FAL PROJECTION OF THE RO	ER OF THE EXTERIOR DURTS, WITHOUT RIOR WALLS, COLUMNS, UNDING EXTERIOR DOF OR FLOOR ABOVE.	
						PROJECT SITE

DESIGN & PLANNING

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CLIENT

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PROJECT

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SHEET TITLE

**COVER SHEET** 

REVISIONS

PROJECT NAME HERE PROJECT NAME

DATE DRAWN

# CLIENT PLACEHOLDER SHEET FOR SITE PHOTOS PROJECT SHEET TITLE REVISIONS PROJECT NAME DATE DRAWN SHEET NO.

DESIGN & PLANNING

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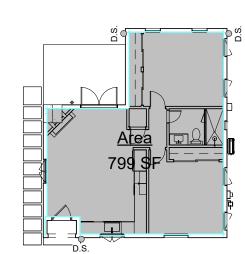
SITE PHOTOS


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**EXISTING AREA - NET** SCALE: 1/16" = 1'-0"

**EXISITING AREA - GROSS** 

SCALE: 1/16" = 1'-0"



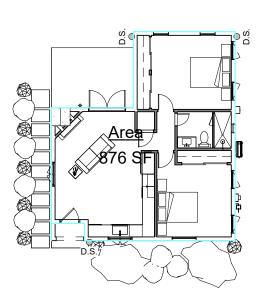

PROPOSED AREA - NET SCALE: 1/16" = 1'-0" PROPOSED AREA - GROSS

SCALE: 1/16" = 1'-0"

PROPOSED NET AREA

PROPOSED ADU

799 SF NET

0 SF NET

PROPOSED ADU

PROPOSED GROSS AREA

876 SF GROSS

**EXISTING NET AREA** 

EXISTING RESIDENCE

EXISTING RESIDENCE

**EXISTING GROSS AREA** 

0 SF GROSS

NET FLOOR AREA

FLOOR AREA. THE TOTAL HORIZONTAL ENCLOSED AREA OF ALL THE FLOORS BELOW THE ROOF AND WITHIN THE EXTERIOR WALLS OF A BUILDING OR ENCLOSED STRUCTURE. THE FLOOR AREA OF AN UNENCLOSED BUILDING OR STRUCTURE INCLUDES ALL HORIZONTAL AREA BELOW THE ROOF LINE. SEE ALSO SECTION 30.15.070, MEASURING FLOOR AREA.

LIVABLE FLOOR AREA. THE TOTAL ENCLOSED AND USABLE SPACE AVAILABLE WITHIN THE EXTERIOR WALLS ON ALL FLOORS OF A BUILDING, INCLUDING INTERIOR CORRIDORS, STAIRS, ELEVATORS, PASSAGEWAYS, AND FINISHED BASEMENTS, CELLARS, AND ATTICS. UNFINISHED AND UNHEATED AREAS INCLUDING, BUT NOT LIMITED TO: BASEMENTS, CELLARS, ATTICS, PORCHES, BREEZEWAYS, GARAGES, SHEDS AND WORKSHOPS ARE EXCLUDED FROM LIVABLE FLOOR AREA DETERMINATIONS. BASEMENT, CELLARS, OR ATTIC AREAS ARE CONSIDERED FINISHED IF ALL OF THE WALLS, CEILINGS, AND FLOORS ARE FINISHED. WALLS AND CEILINGS SHALL BE DEEMED FINISHED ONLY IF THEY ARE COVERED WITH PLASTER, WALLBOARD, OR SIMILAR MATERIAL; FLOORS SHALL BE DEEMED FINISHED ONLY IF THEY ARE COVERED WITH CARPETING, TILE, LINOLEUM, OR SIMILAR MATERIAL.

30.15.070 MEASURING FLOOR AREA.

THE NET FLOOR AREA OF A STRUCTURE IS THE SUM, IN SQUARE FEET, OF THE HORIZONTAL AREAS OF ALL FLOORS OF A STRUCTURE OR OTHER ENCLOSED STRUCTURE. OR PORTIONS THEREOF, MEASURED FROM EITHER THE INTERIOR PERIMETER OF THE EXTERIOR WALLS, OR BELOW THE ROOFLINE, OR THE CENTERLINE OF INTERIOR WALLS, AS DESCRIBED BELOW. ALL REFERENCES TO FLOOR AREA IN THIS TITLE ARE TO NET FLOOR AREA, UNLESS OTHERWISE INDICATED. THE FOLLOWING ARE INCLUDED IN AND EXCLUDED FROM FLOOR AREA EXCEPT AS OTHERWISE PROVIDED IN THIS TITLE.

A. INCLUDED IN FLOOR AREA.

1. **ENCLOSED STRUCTURES**. NET FLOOR AREA INCLUDES ALL SPACE WITHIN A STRUCTURE THAT IS BELOW THE ROOF AND WITHIN THE INTERIOR PERIMETER OF THE EXTERIOR WALLS OF ANY MAIN OR ACCESSORY STRUCTURE.

2. **INTERIOR SPACES**. NET FLOOR AREA OF INTERIOR SPACES, SUCH AS ROOMS OR SEPARATE TENANT SPACES, INCLUDES ALL SPACE WITHIN THE CENTERLINES OF DEMISING WALLS SEPARATING SUCH SPACES OR PORTIONS THEREOF.

3. STAIRWAYS AND ELEVATOR SHAFTS. IN THE CASE OF A MULTISTORY STRUCTURE THAT HAS COVERED OR ENCLOSED STAIRWAYS, STAIRWELLS, OR ELEVATOR SHAFTS, THE FLOOR AREA OF SUCH FEATURES IS COUNTED ONLY ONCE AT THE FLOOR LEVEL OF THEIR GREATEST AREA OF HORIZONTAL EXTENT.

4. **UNENCLOSED STRUCTURES**. THE NET FLOOR AREA OF A STRUCTURE WITH NO WALLS, OR PARTIAL WALLS, SUCH AS A CARPORT, INCLUDES ALL SPACE BELOW THE ROOF LINE.

B. **EXCLUDED FROM FLOOR AREA.** THE FOLLOWING AREAS ARE EXCLUDED FROM FLOOR

1. VENT SHAFTS OR AREAS WITH A CEILING HEIGHT OF LESS THAN FIVE FEET ABOVE FINISHED

2. ATTICS, CRAWLSPACES, OR SIMILAR AREAS, WHERE ENTRY IS MADE ONLY FOR SERVICE OF UTILITIES, AND NOT DESIGNED FOR USE AS STORAGE OR ANY OTHER USE WHATSOEVER.

B. UNENCLOSED ROOFED AREAS SUCH AS PATIO COVERS, PORCHES, TRELLISES, GAZEBOS, SHADE STRUCTURES, OR OTHER SIMILAR UNENCLOSED STRUCTURES NOT USED FOR THE SHELTER, HOUSING, OR ENCLOSURE OF PERSONS, ANIMALS, OR PROPERTY.

4. ENCLOSED SPACES IN NONRESIDENTIAL OR MIXED-USE STRUCTURES THAT CONTAIN "INFRASTRUCTURE" (E.G., MECHANICAL EQUIPMENT ENCLOSURES, VENT SHAFTS, TRASH AND RECYCLING ENCLOSURES, AIR CONDITIONERS, FORCED AIR UNITS, ELECTRIC VAULTS, WATER HEATERS AND SOFTENERS, CELLULAR TELEPHONE EQUIPMENT, AND OTHER SIMILAR USES) SHALL NOT COUNT TOWARD THE CALCULATION OF FLOOR AREA IF SUCH AREAS ARE DESIGNED IN THE MINIMUM SIZE NECESSARY TO SCREEN OR ENCLOSE SUCH EQUIPMENT, AND THE SPACE CANNOT BE CONVERTED TO STORAGE OR ANOTHER NON-INFRASTRUCTURE USE.

5. NONLIVABLE RESIDENTIAL ACCESSORY STRUCTURES THAT DO NOT REQUIRE A BUILDING PERMIT FOR CONSTRUCTION OR INSTALLATION.

6. TEMPORARY STRUCTURES PERMITTED WITH A TEMPORARY USE PERMIT.

DESIGN & PLANNING

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SHEET TITLE

AREA PLANS

REVISIONS

PROJECT NAME HERE

PROJECT NAME

DATE DRAWN

SHEET NO.

T-1.4


### MATERIALS BOARD



NUMBER OF BULBS: 1 BULB BASE: MEDIUM (E26) BULB TYPE: COMPACT FLUORESCENT WATTS PER BULB: 100 WATTAGE: 100 HEIGHT: 19" WIDTH: 11" **ENERGY STAR: NO** MOTION SENSOR: NO PHOTOCELL: NO SOLAR: NO UL LISTED: YES UL RATING: WET LOCATION UL LISTED - INDICATES WHETHER A PRODUCT MEETS STANDARDS AND COMPLIANCE GUIDELINES SET BY UNDERWRITERS LABORATORIES. THIS LISTING DETERMINES WHAT TYPES OF ROOMS OR ENVIRONMENTS A PRODUCT CAN BE USED IN SAFELY.



NUMBER OF BULBS: 1 BULB BASE: MEDIUM (E26) BULB TYPE: COMPACT FLUORESCENT WATTS PER BULB: 100 WATTAGE: 100 HEIGHT: 20" WIDTH: 14.25" **ENERGY STAR: NO** MOTION SENSOR: NO PHOTOCELL: NO SOLAR: NO UL LISTED: YES UL RATING: WET LOCATION UL LISTED - INDICATES WHETHER A PRODUCT MEETS STANDARDS AND COMPLIANCE **GUIDELINES SET BY UNDERWRITERS** LABORATORIES. THIS LISTING DETERMINES WHAT TYPES OF ROOMS OR ENVIRONMENTS A PRODUCT CAN BE USED IN SAFELY.

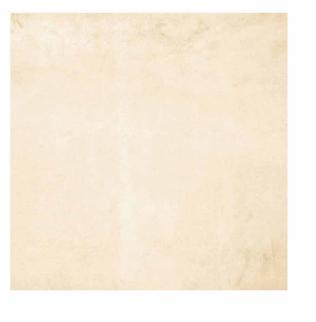

#### EX-01 EXTERIOR STUCCO

TEXTURE: COLOR: SMOOTH OR STEEL TROWEL TO MATCH EXISTING MAIN RESIDENCE OR TO BE TAN AS PROPOSED



**EX-04 TILE PATIO** 

COLOR: RED, TERRACOTTA, HONEY, CHOCOLATE

SIZES: 12" X 12" X 1/2" NOMINAL
ACTUAL SIZE: 11 3/4" X 11 3/4" X 7/16"
EDGE DETAIL: FINISHED
GROUT JOINT: 3/8" RECOMMENDED
WEIGHT: 12" X 12": 4.7 LBS.; STEP NOSE: 5.8 LBS.
SURFACE: SMOOTH NATURAL CLAY SURFACE (UNGLAZED)
BACK: NOTCHED TO PROVIDE A BETTER BONDING SURFACE
TRIM: STEP NOSE



**EX-02 SPANISH STYLE ROOF TILE** 

COLOR:


TERRACOTTA OR TO MATCH EXISTING MAIN RESIDENCE ROOF COLOR



EX-03 ALUM. CLAD WINDOWS AND DOORS

COLOR:

BRONZE COLORING PROPOSED OR TO MATCH EXISTING COLOR OF MAIN RESIDENCE

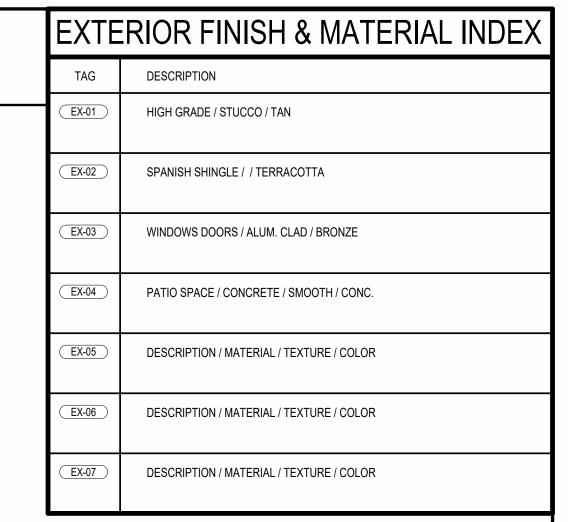

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SPANISH MATERIALS BOARD

REVISIONS

PROJECT NAME

DATE DRAWN

DATE 04.

SHEET NO.


MATERIAL VIEW

SCALE: 1/2" = 1'-0"

T-1.5

PROJECT NAME HERE



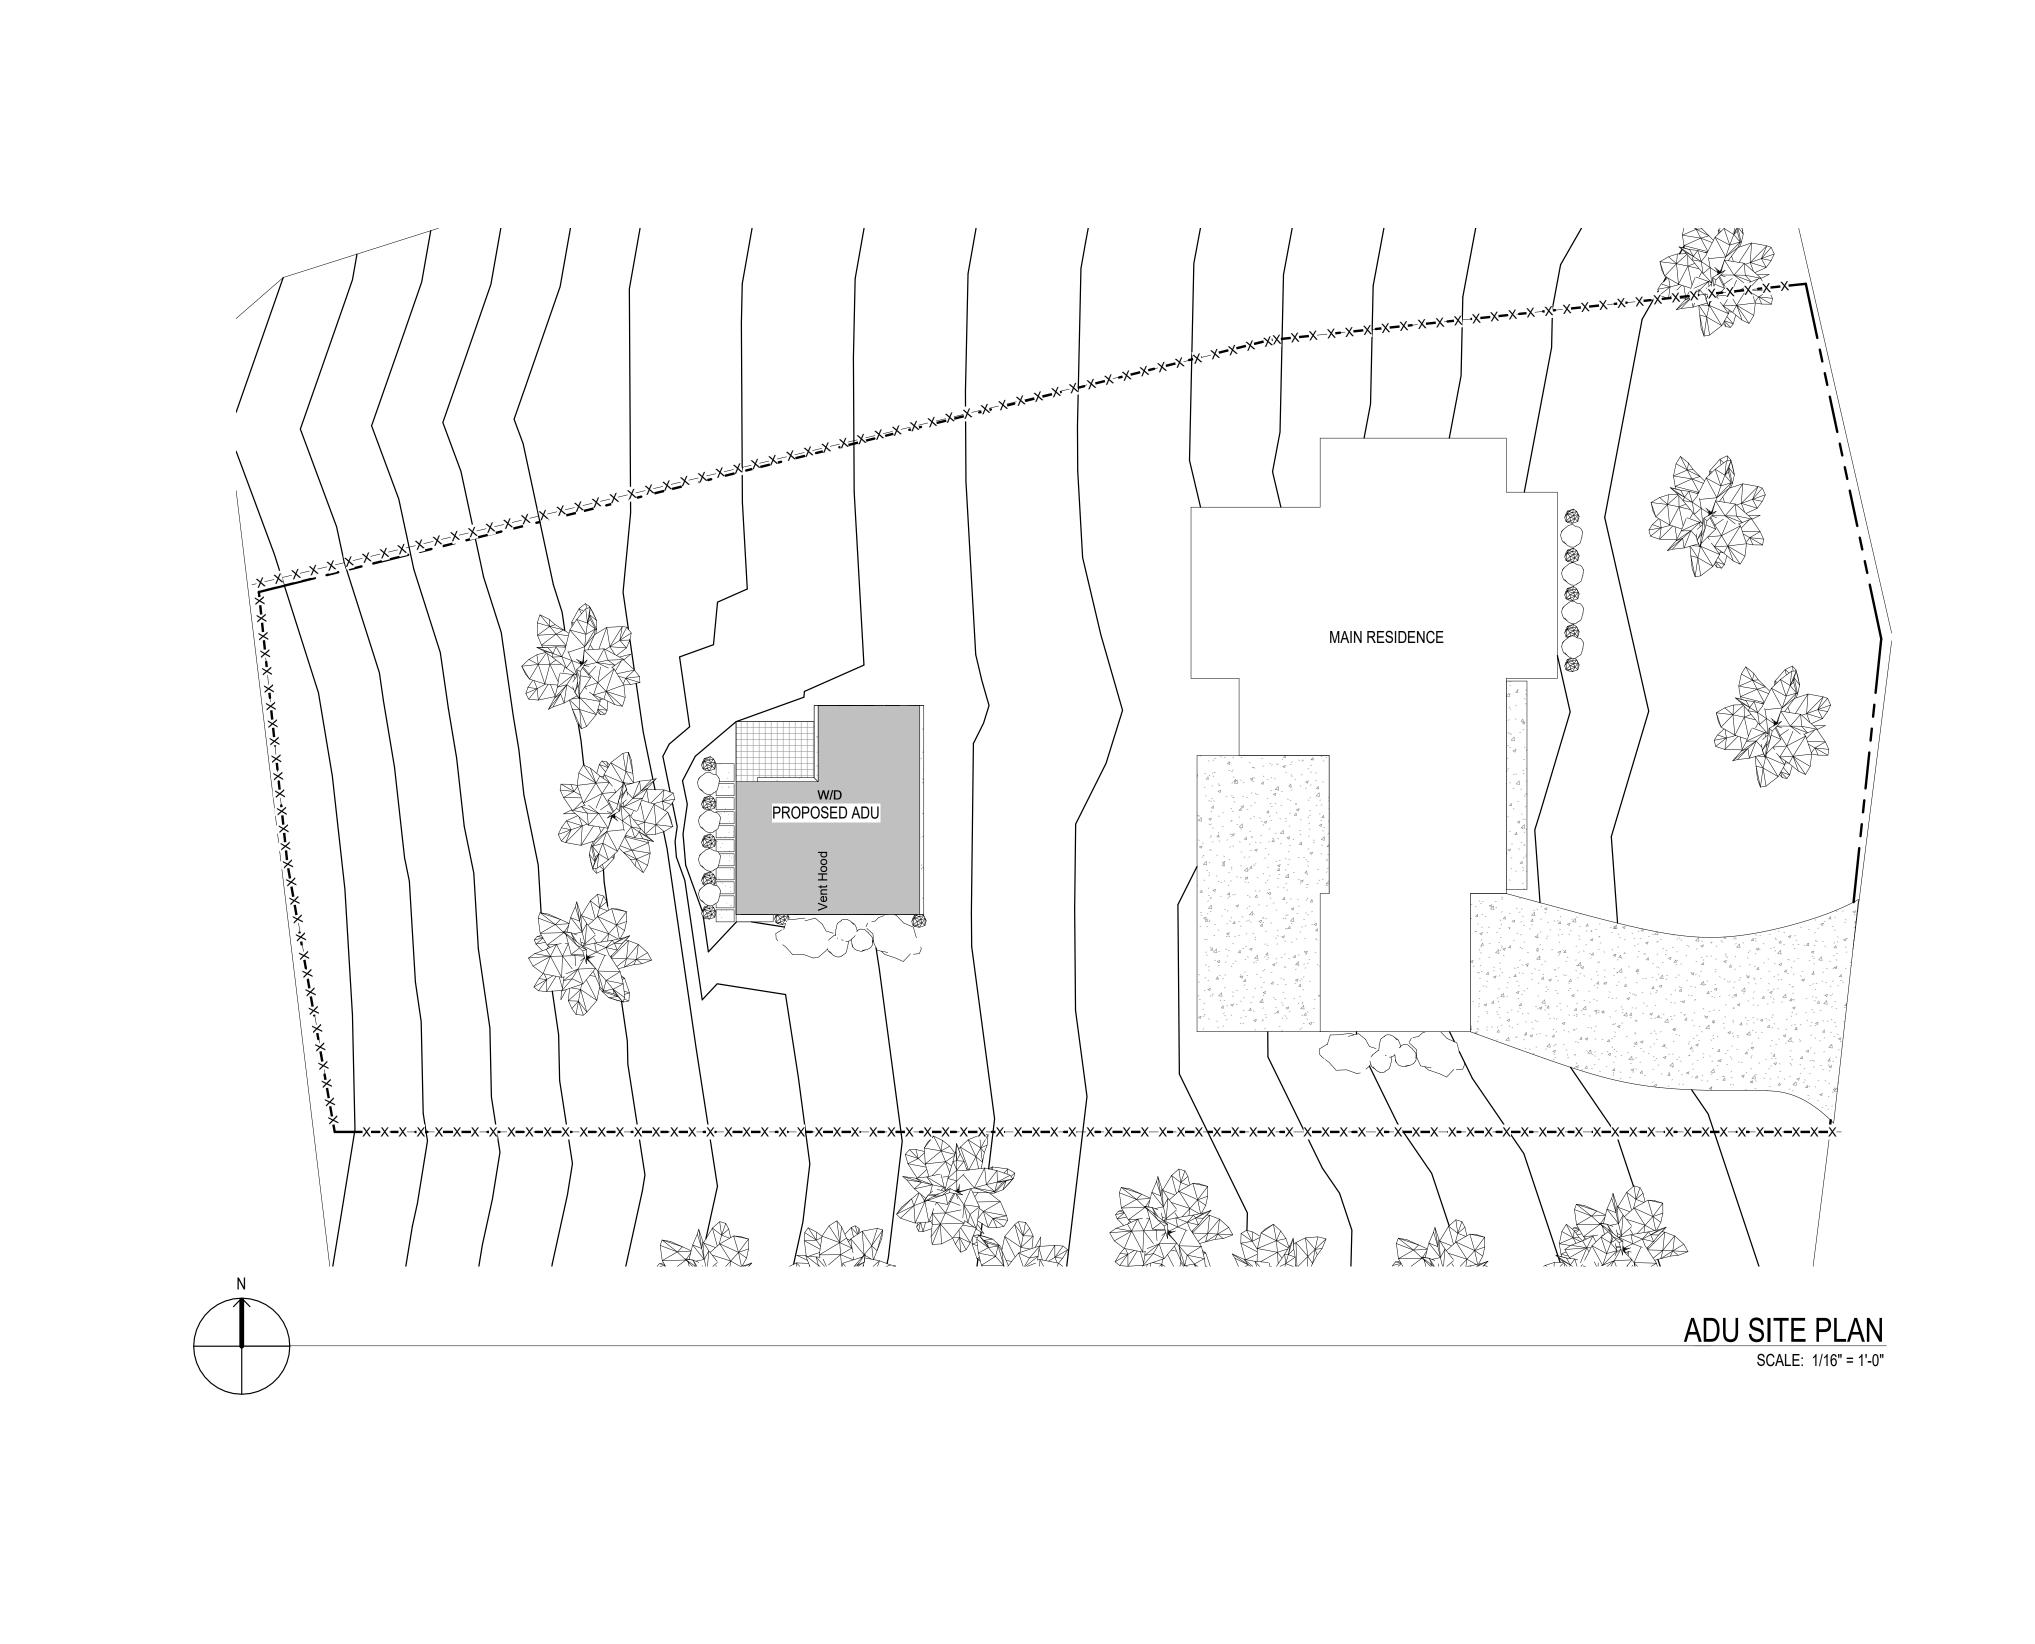

#### SITE PLAN LEGEND

PROPERTY LINE

—X——X— 5' HIGH WOODEN FENCE (1X6' HORIZ.) FENCE 42" GATE

—G——G— GAS LINE

—E——E— ELECTRIC

—S——S— SEWER

—W——W— WATER

ENGINEER.

CLEANOUT

HOSE BIBB

DRAINAGE FLOW DIRECTION

#### GENERAL NOTES - SITE PLAN

 SEE CIVIL DRAWINGS FOR LOCATIONS OF BMPS
 FINISH GRADE AROUND STRUCTURE SHALL SLOPE AWAY FROM FOUNDATION MINIMUN OF 6" FOR A MINIMUM DISTANCE OF 10' FEET

#### STORMWATER CONTROL NOTES

- CONTRACTOR SHALL SCHEDULE STORM DRAIN WORK AHEAD OF OTHER UNDERGROUND CONDUIT CONSTRUCTION.
   GRAVITY STORM DRAIN WORK SHALL BEGIN AT THE LOWEST POINT OF DISCHARGE AND
- PROCEED UPSTREAM.

  3. POLYVINYL CHLORIDE (PVC) PIPE FOR 4" THROUGH 15" SIZE SHALL COMPLY WITH THE MOST RECENT ISSUE OF ASTM STANDARD D-3034 (SDR 35). PVC PIPE SHALL HAVE AN INTEGRALLY MOLDED BELL OR SOCKET END FOR GASKETED JOINT ASSEMBLY. JOINTS AND GASKETS SHALL COMPLY WITH THE MOST RECENT ISSUE OF ASTM STANDARD D-3212 AND F-477, RESPECTIVELY. PVC PIPE INSTALLATION SHALL COMPLY WITH UNI-BELL PLASTIC PIPE ASSOCIATION STANDARD UNI-B-5, LATEST REVISION. PVC PIPE CONNECTIONS TO MANHOLES, CATCH BASINS AND OTHER CONCRETE STRUCTURES SHALL BE CONSTRUCTED WITH WATERSTOP AT MIDPOINT OF STRUCTURE WALL PENETRATION. WATERSTOP SHALL BE PVC CONCRETE MANHOLE ADAPTER (4" THROUGH 12" PIPE) OR LARGE DIAMETER WATERSTOP AS MANUFACTURED BY FERNCO, OR EQUIVALENT APPROVED BY THE
- HIGH DENSITY POLYETHYLENE (HDPE) PIPE AND FITTINGS FOR 4" THROUGH 48" SIZE SHALL BE N-12PROLINK WT (WATERTIGHT) SERIES AS MANUFACTURED BY ADVANCED DRAINAGE SYSTEMS, INC. (ADS). UNLESS NOTED OTHERWISE. LATERAL CONNECTIONS TO MAINLINES SHALL BE MADE USING MANUFACTURER'S WATERTIGHT REDUCING FITTINGS. PIPE AND FITTING INSTALLATION SHALL BE IN ACCORDANCE WITH MANUFACTURER'S RECOMMENDED PROCEDURES. CONNECTIONS TO CONCRETE STRUCTURES SHALL BE CONSTRUCTED WATERTIGHT USING MANUFACTURER'S RECOMMENDED MATERIALS AND METHODS.
   GRATED CATCH BASINS SHALL BE CONSTRUCTED IN ACCORDANCE WITH THE PLAN DETAIL
   QUALITY REVIEW AND REPORTING MEASUREMENTS.
- A. CONTRACTOR SHALL REQUEST INSPECTION BY ENGINEER OF WORK AFTER
  INSTALLATION AND ASSEMBLY OF STORM DRAINAGE PIPING, BUT BEFORE COVERING.
   B. CONTRACTOR SHALL REQUEST INSPECTION BY ENGINEER OF WORK AFTER FORMING
  AND PLACING REINFORCING STEEL FOR CAST-IN-PLACE DRAINAGE STRUCTURES, BUT
- BEFORE SCHEDULING THE CONCRETE POUR.

  C. WITHIN TEN (10) WORKING DAYS OF COMPLETION OF THE STORM DRAIN SYSTEM AND BEFORE CONSTRUCTION OF PAVEMENT, WALKWAYS AND OTHER PERMANENT SURFACE IMPROVEMENTS, CONTRACTOR SHALL PROVIDE A CONSTRUCTION RECORD DRAWING OF THE SYSTEM TO INCLUDE TOP OF GRATE OR COVER AND INLET AND OUTLET INVERT ELEVATIONS OF ALL STORM DRAIN STRUCTURES. ELEVATION
- MEASUREMENTS SHALL BE ACCURATE TO 0.01 FEET.

  D. UPON COMPLETION OF CONSTRUCTION OF THE STORM DRAIN SYSTEM AND WITH 48 HOURS NOTICE TO ENGINEER OF WORK, CONTRACTOR SHALL THOROUGHLY CLEAN AND WASH DOWN ALL INLETS AND STORM DRAIN PIPING USING FIRE HYDRANT FLOWS.

#### GENERAL NOTES - GRADING

ALL GRADING SHALL CONFORM WITH SANTA BARBARA COUNTY CODE CHAPTER 14 GRADING ORDINANCE #4477 AND STANDARDS AND REQUIREMENTS PERTAINING THERETO, THESE CONSTRUCTION DRAWINGS AND THE RECOMMENDATIONS OF THE SOILS ENGINEER AND ENGINEERING GEOLOGIST.

- 2. CONTRACTOR TO NOTIFY THE COUNTY GRADING INSPECTOR AND SOILS LABORATORY AT LEAST **48 HOURS** BEFORE START OF GRADING WORK OR PRE-CONSTRUCTION MEETING.
- 3. CONTRACTOR SHALL EMPLOY ALL LABOR, EQUIPMENT AND METHODS REQUIRED TO PREVENT HIS OPERATIONS FROM PRODUCING DUST IN AMOUNTS DAMAGING TO ADJACENT PROPERTY, CULTIVATED VEGETATION AND DOMESTIC ANIMALS **OR** CAUSING A NUISANCE TO PERSONS OCCUPYING BUILDINGS IN THE VICINITY OF THE JOB SITE. CONTRACTOR SHALL BE RESPONSIBLE FOR DAMAGE CAUSED BY DUST FROM HIS GRADING OPERATION.
- 4. BEFORE BEGINNING WORK REQUIRING EXPORTING OR IMPORTING OF MATERIALS, THE CONTRACTOR SHALL OBTAIN APPROVAL FROM THE PUBLIC WORKS ROAD DIVISION FOR HAUL ROUTES USED AND METHODS PROVIDED TO MINIMIZE THE DEPOSIT OF SOILS ON COUNTY ROADS. GRADING/ROAD INSPECTORS SHALL MONITOR THIS REQUIREMENT WITH THE CONTRACTOR.
- 5. THE GEOTECHNICAL ENGINEER SHALL PROVIDE OBSERVATION AND TESTING DURING GRADING OPERATIONS IN THE FIELD AND SHALL SUBMIT A FINAL REPORT STATING THAT ALL EARTH WORK WAS PROPERLY COMPLETED AND IS IN SUBSTANTIAL CONFORMANCE WITH THE REQUIREMENTS OF THE GRADING ORDINANCE.
- 6. AREAS TO BE GRADED SHALL BE CLEARED OF ALL VEGETATION INCLUDING ROOTS AND OTHER UNSUITABLE MATERIAL FOR A STRUCTURAL FILL, THEN SCARIFIED TO A DEPTH OF 6" PRIOR TO PLACING OF ANY FILL. CALL GRADING INSPECTOR FOR INITIAL INSPECTION.
- 7. A THOROUGH SEARCH SHALL BE MADE FOR ALL ABANDONED MAN-MADE FACILITIES SUCH AS SEPTIC TANK SYSTEMS, FUEL OR WATER STORAGE TANKS, AND PIPELINES OR CONDUITS. ANY SUCH FACILITIES ENCOUNTERED SHALL BE REMOVED AND THE DEPRESSION PROPERLY FILLED AND COMPACTED UNDER OBSERVATION OF THE GEOTECHNICAL ENGINEER.
- 3. AREAS WITH EXISTING SLOPES WHICH ARE TO RECEIVE FILL MATERIAL SHALL BE KEYED AND BENCHED. THE DESIGN AND INSTALLATION OF THE KEYWAY SHALL BE PER THE GEOTECHNICAL ENGINEER'S RECOMMENDATION OR PER COUNTY STANDARD DETAIL NO.
- 9. FILL MATERIAL SHALL BE SPREAD IN LIFTS NOT EXCEEDING 6" IN COMPACTED THICKNESS, MOISTENED OR DRIED AS NECESSARY TO NEAR OPTIMUM MOISTURE CONTENT AND COMPACTED BY AN APPROVED METHOD. FILL MATERIAL SHALL BE COMPACTED TO A MINIMUM OF 90% MAXIMUM DENSITY AS DETERMINED BY 1957 ASTM D 1557 91 MODIFIED PROCTOR (AASHO) TEST OR SIMILAR APPROVED METHODS. SOME FILL AREAS MAY REQUIRE COMPACTION TO A GREATER DENSITY IF CALLED FOR IN THE CONSTRUCTION DOCUMENTS. SOIL TESTS SHALL BE CONDUCTED AT NOT LESS THAN ONE TEST FOR EACH 18" OF FILL AND/OR FOR EACH 500 CUBIC YARDS OF FILL PLACED.
- O. CUT SLOPES SHALL NOT EXCEED A GRADE OF 1½-HORIZONTAL TO 1-VERTICAL. FILL AND COMBINATION FILL AND CUT SLOPES SHALL NOT EXCEED 2-HORIZONTAL TO 1-VERTICAL. SLOPES OVER 3-FEET IN VERTICAL HEIGHT SHALL BE PLANTED WITH APPROVED PERENNIAL VEGETATION OR TREATED WITH EQUALLY APPROVED EROSION CONTROL MEASURES PRIOR TO FINAL INSPECTION.
- SURFACE DRAINAGE SHALL BE PROVIDED AT A MINIMUM OF 2% FOR 5 FEET AWAY FROM THE FOUNDATION LINE OR ANY STRUCTURE.
- 2. ALL TREES THAT ARE TO REMAIN ON SITE SHALL BE TEMPORARILY FENCED AND PROTECTED AROUND THE DRIP LINE DURING GRADING OPERATION.
- 3. AN EROSION AND SEDIMENT CONTROL PLAN SHALL BE REQUIRED AS PART OF THE GRADING PLAN AND PERMIT REQUIREMENTS.

**DESIGN & PLANNING** 

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SHEET TITLE

SITE PLAN


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DATE DRAWN

DATE 01/01/2013
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#### INSULATION SCHEDULE

PROVIDE THERMAL INSULATION AS SHOWN ON THE DRAWINGS, WITH THE FOLLOWING

EXISTING 2X4 EXTERIOR WALLS AND WALLS BETWEEN HEATED AND UNHEATED SPACES: R-13 BATT INSULATION

NEW 2X6 EXTERIOR WALLS AND WALLS BETWEEN HEATED AND UNHEATED SPACES: R-19 BATT INSULATION

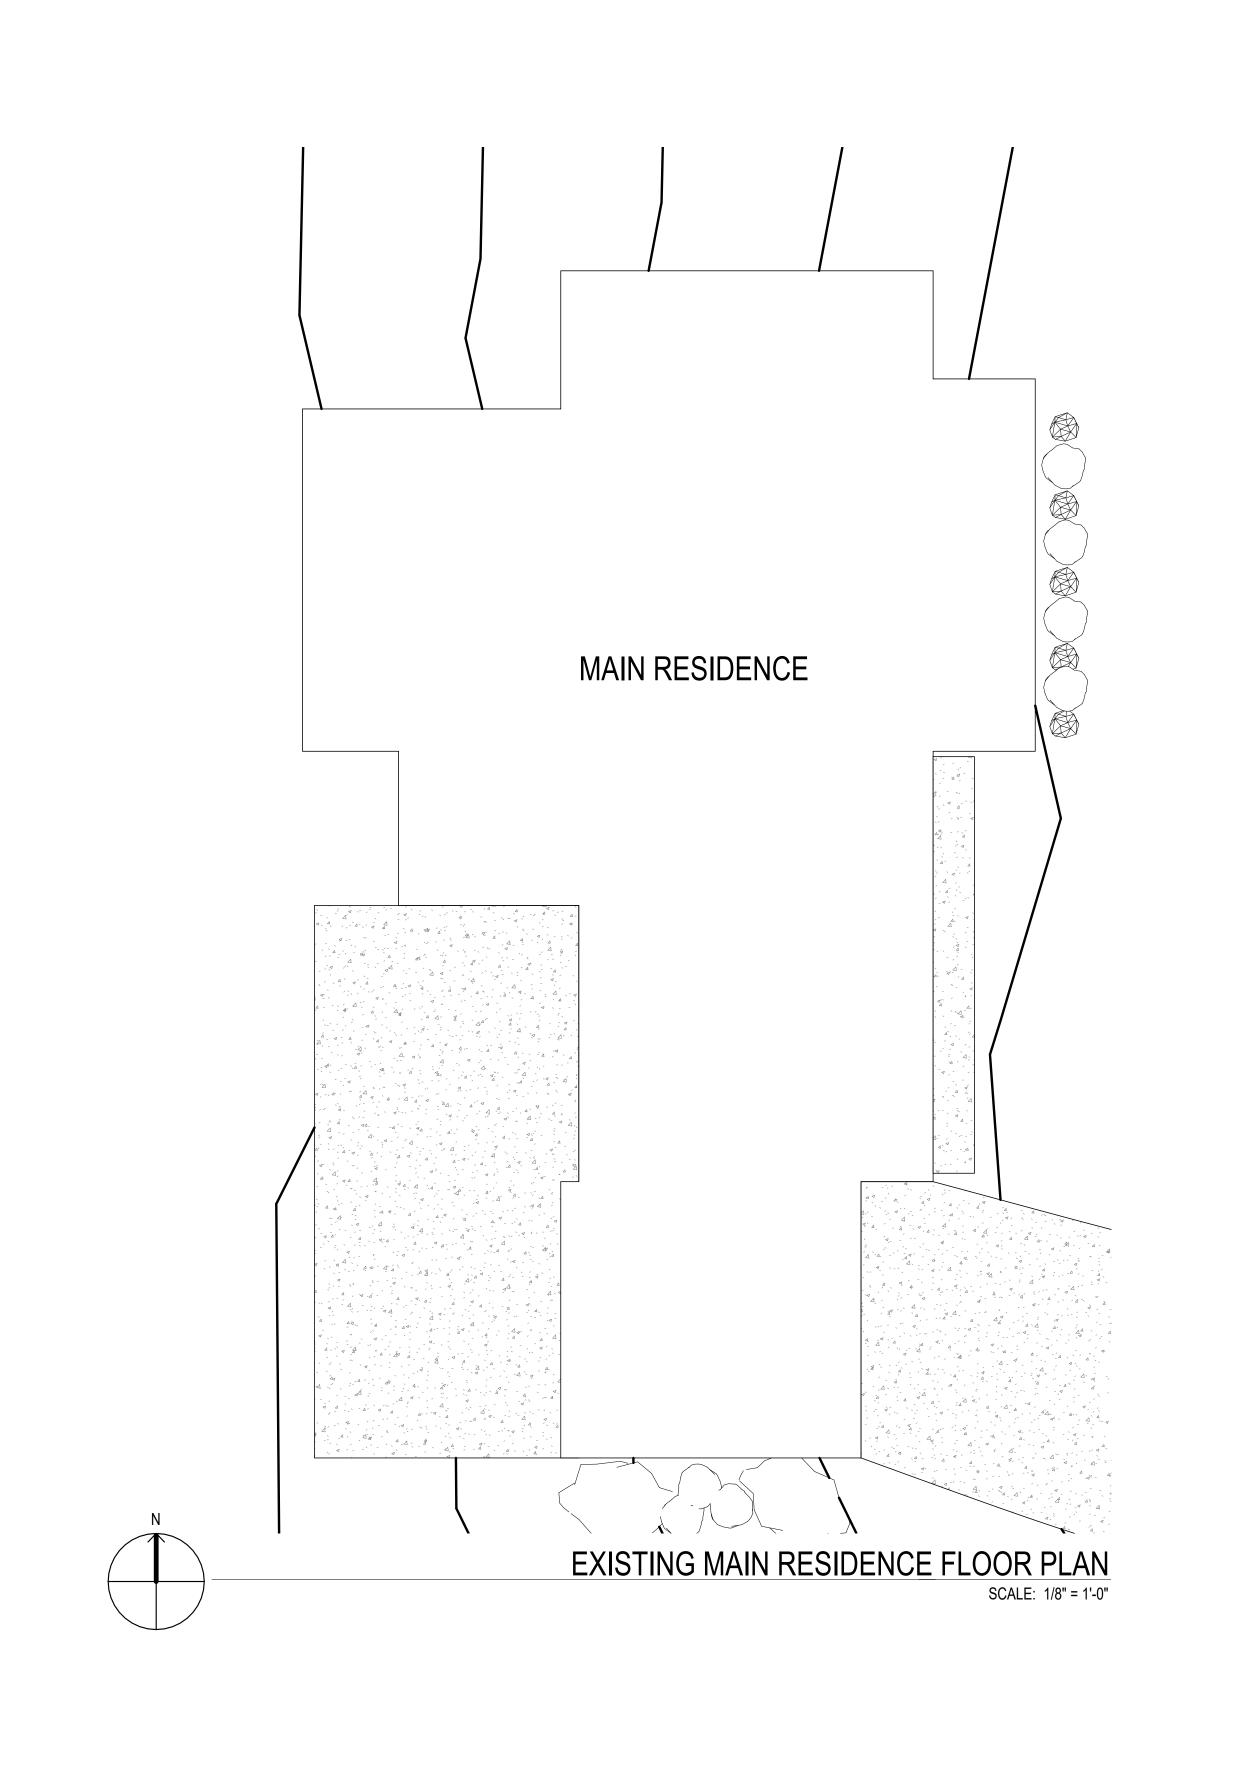ROOF INSULATION: R-30 CLOSED CELL ICYNENE INSULATION AT UNDERSIDE OF ROOF SHEATHING

INSULATE ALL PIPE & MECHANICAL CHASES FOR SOUND.

PROVIDE ROCK WOOL INSULATION OR EQUIVALENT BETWEEN ALL WINDOW AND EXTERIOR DOOR FRAME AND ROUGH FRAMING.

#### WALL LEGEND

EXISTING WALL

— — EXISTING WALL TO BE DEMOLISHED



NEW EXTERIOR WALL: WOOD BOARD AND BATT SIDING, WEATHER RESISTIVE AIR BARRIER, PLYWOOD SHEATHING, 2X6 FRAMING, INT. 5/8" GYPSUM WALL BOARD

NEW INTERIOR WALL: 2X4 WOOD FRAMING W 5/8" GYPSUM WALL BOARD BOTH SIDES, PROVIDE MOISTURE RESISTANT DRYWALL AS NOTED ON PLANS

#### KEYNOTES

X.XX KEYNOTE DESIGNATION

**KEYNOTE TEXT** 

DESIGN & PLANNING

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SHEET TITLE **EXISTING** 

RESIDENCE FLOOR PLAN


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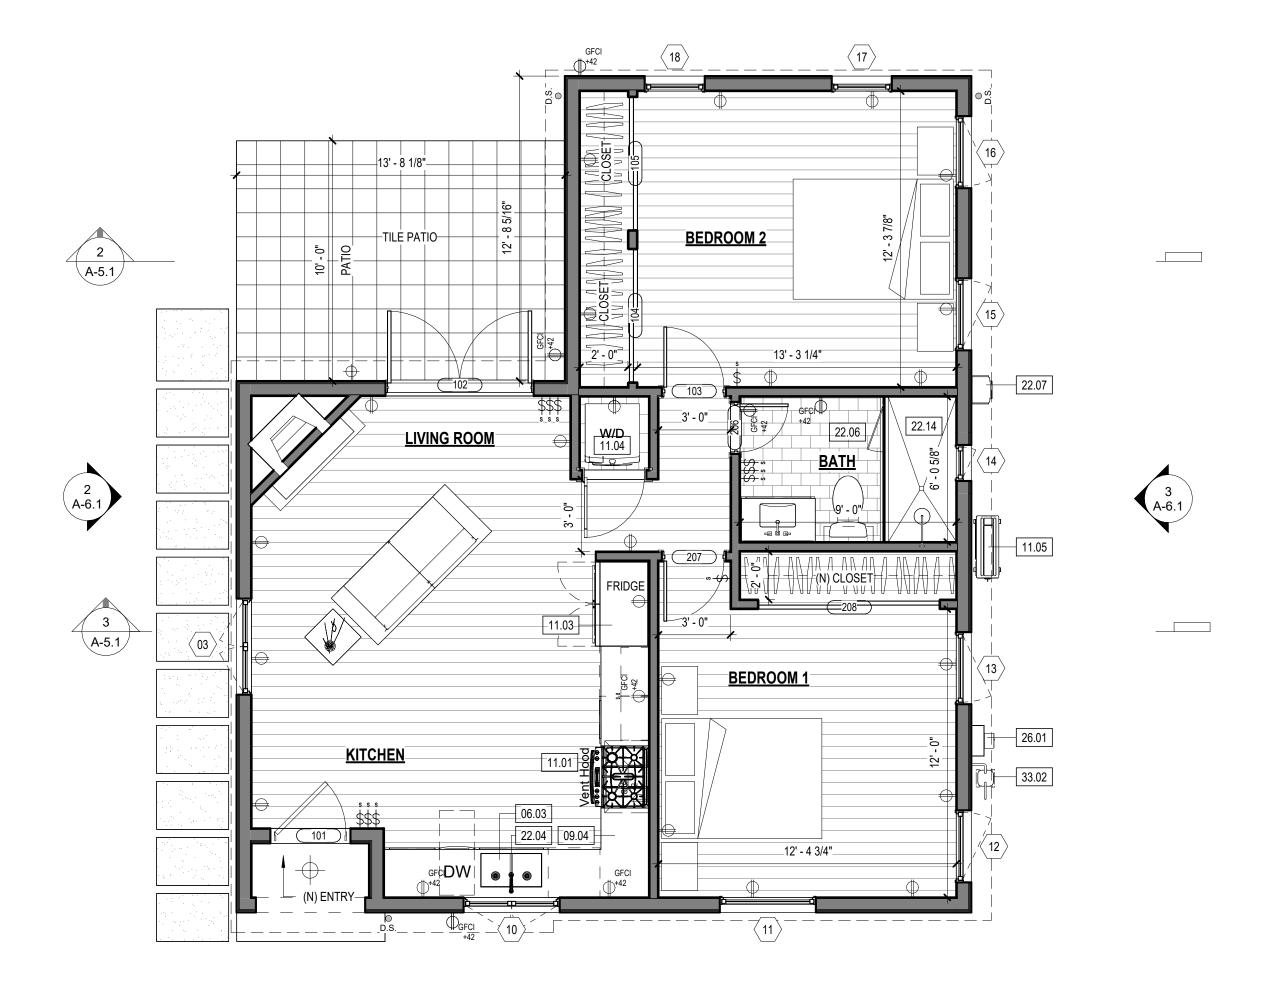
PROJECT NAME HERE PROJECT NAME

DATE DRAWN


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A-2.10





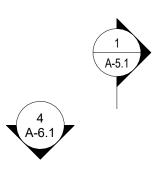

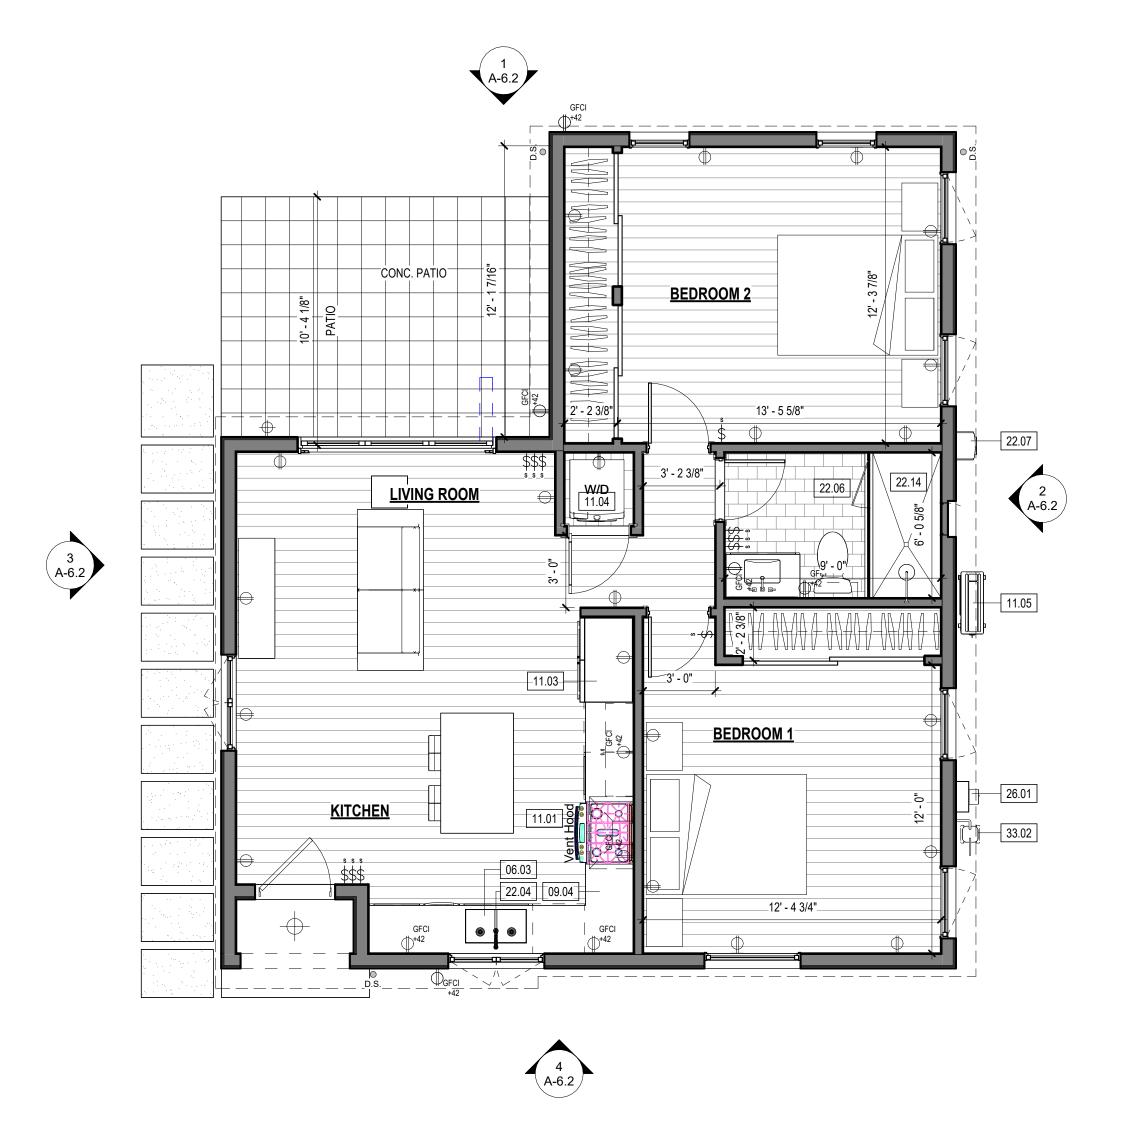

PROPOSED SPANISH STYLE OPTION 2 W/O FIREPLACE SCALE: 1/4" = 1'-0"

#### INSULATION SCHEDULE

PROVIDE THERMAL INSULATION AS SHOWN ON THE DRAWINGS, WITH THE FOLLOWING

EXISTING 2X4 EXTERIOR WALLS AND WALLS BETWEEN HEATED AND UNHEATED SPACES: R-13 BATT INSULATION

NEW 2X6 EXTERIOR WALLS AND WALLS BETWEEN HEATED AND UNHEATED SPACES:

R-19 BATT INSULATION

**ROOF INSULATION:** R-30 CLOSED CELL ICYNENE INSULATION AT UNDERSIDE OF ROOF SHEATHING

INSULATE ALL PIPE & MECHANICAL CHASES FOR SOUND.

PROVIDE ROCK WOOL INSULATION OR EQUIVALENT BETWEEN ALL WINDOW AND EXTERIOR DOOR FRAME AND ROUGH FRAMING.

#### WALL LEGEND

EXISTING WALL

— — EXISTING WALL TO BE DEMOLISHED

NEW EXTERIOR WALL: WOOD BOARD AND BATT SIDING, WEATHER RESISTIVE AIR BARRIER, PLYWOOD SHEATHING, 2X6 FRAMING, INT. 5/8" GYPSUM WALL BOARD

NEW INTERIOR WALL: 2X4 WOOD FRAMING W 5/8" GYPSUM WALL BOARD BOTH SIDES, PROVIDE MOISTURE RESISTANT DRYWALL

#### KEYNOTES

X.XX KEYNOTE DESIGNATION

**KEYNOTE TEXT** 

06.03 24" DEEP CABINETRY BELOW 09.04 | 36" HIGH COUNTERTOP - SEE INTERIOR ELEVATIONS 11.01 | RANGE/ OVEN W/ HOOD ABOVE 11.03 | REFRIGERATOR - PROVIDE ELECTRIC OUTLET AT

42" AND COLD WATER HOOK-UP; GE REFRIGERATOR: 21.2 CUFT STAINLESS W TOP FREEZER GIEZ1GSHSS

11.04 WASHER AND DRYER STACKED 11.05 | NEW CONDENSER WITH ANCHORED SEISMIC STRAPPING ON 4" MINIMUM CONCRETE PAD 3" ABOVE GRADE. PROVIDE 1 GFI/WP OUTLET WITHIN 25 FEET OF UNIT AND A DISCONNECT SWITCH BY THE UNIT PER CEC 210.63.

22.04 KITCHEN FAUCET SHALL NOT EXCEED A WATER FLOW OF 1.8 GPM 22.06 TOILETS SHALL BE 1.28 GPF MAX 22.07 NEW TANKLESS WATER HEATER- INSTALLED IN ACCORDANCE W/ THE CPC, INCLUDING SECTION 507.2 SEISMIC PROVISIONS, SEE T24 DOCUMENTS &

EQUIPENT SCHEDULE FOR ADDITIONAL

REQUIREMENTS AND INFORMATION. 22.14 NEW SHOWER CERAMIC TILE TO CIELING ON SIDES OVER CONCRETE FLOAT. FLOOR FLOOR TILE OVER FLOAT SLOPE TO 3" DRAIN WITH 6X6 TILED CURB ON BOTH SIDES.

26.01 NEW 200 AMP ELECTRICAL METER 33.02 (N) GAS METER LOCATION, SEE PLUMBING

DESIGN & PLANNING

Contractor

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SHEET TITLE PROPOSED SPANISH FLOOR PLANS

REVISIONS


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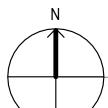
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01/01/2013





LEVEL 1 REFLECTED CEILING PLAN W/ ELECT

GENERAL NOTES - ELECTRICAL ELECTRICAL LEGEND

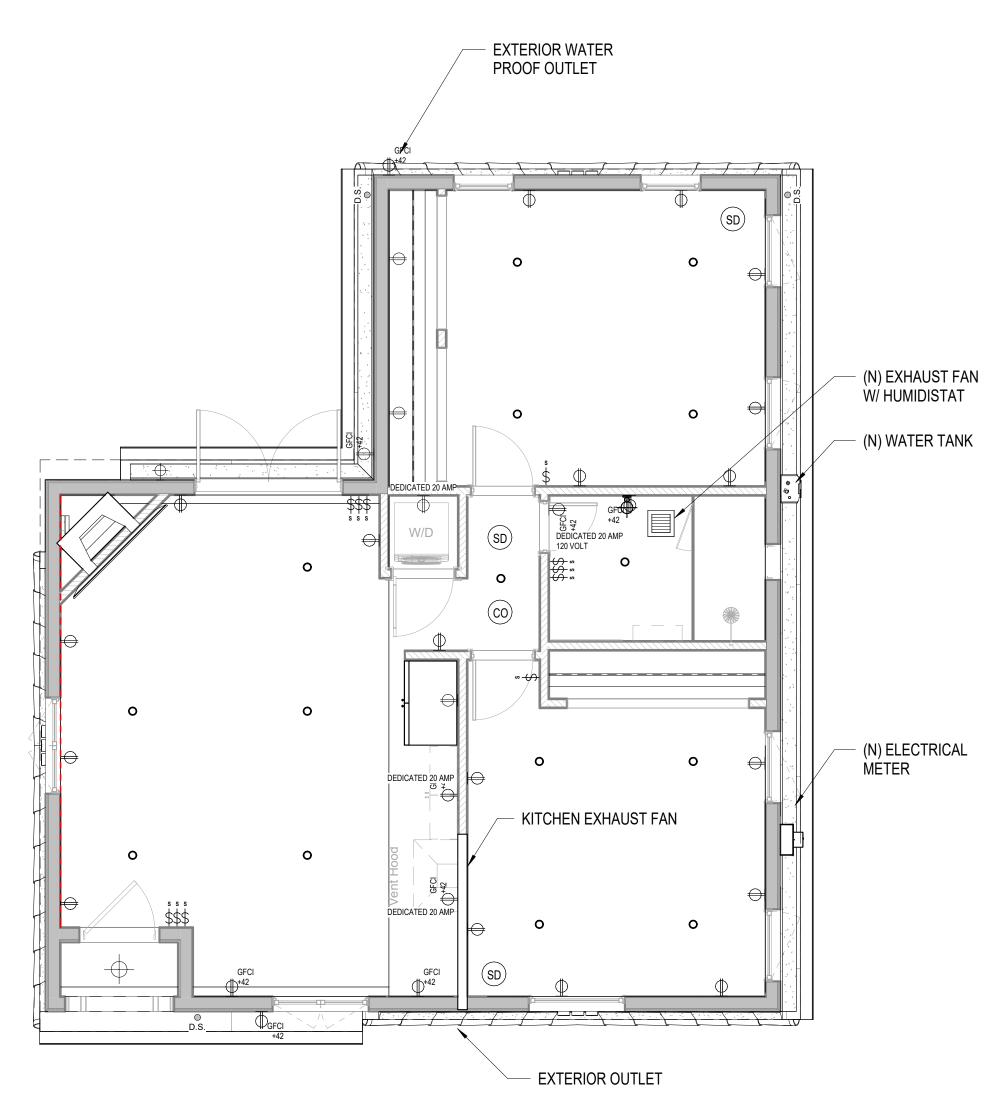DUPLEX POWER OUTLET

DEDICATED DUPLEX POWER OUTLET

DUPLEX POWER OUTLET MOUNTED ABOVE COUNTER, AFF AS NOTED

GROUNDED DUPLEX OUTLET MOUNTED ABOVE COUNTER, AFF AS NOTED

OUTDOOR/ WET LOCATION OUTLET

CABLE TV OUTLET

TELEPHONE / DATA OUTLET

FLUSH BOX. DUPLEX POWER

DATA OUTLET

FLUSH BOX. QUAD POWER

NOTE: SEE ELECTRICAL PLANS

#### RCP LEGEND

MECHANICAL EXHAUST CAPABLE OF 50 CFM AND MAXIMUM 3 SONE. FANS SHALL BE ENERGY STAR COMPLIANT AND SHALL BE DUCTED TO TERMINATE OUTSIDE THE BUILDING

SUPPLY GRILLE, SIZE PER MECH. SUBCONTRACTOR

4" RECESSED CAN (SEE ELECTRICAL DRAWINGS)

RETURN GRILLE, SIZE PER MECH. SUBCONTRACTOR

INTERIOR SCONCE

DECORATIVE PENDANT LIGHT

NATURAL GAS HOOKUP

SMOKE DETECTOR

SEE CUT SHEET

CARBON MONOXIDE DETECTOR

NOTE: SEE LIGHTING PLANS FOR FIXTURE LAYOUT AND INFORMATION

EXTERIOR GOOSENECK SCONCE - DARK SKY COMPLIANT,

#### **ENERGY NOTES**

ALL INSTALLED LIGHTING SHALL BE HIGH EFFICACY PER TABLE 150..0-A 2019 CALIFORNIA ENERGY CODE TABLE 150.0 LIGHTING IN BATHROOMS: ALL LIGHTING IN BATHROOMS SHALL BE HIGH EFFICACY AND AT

LEAST ONE FIXTURE IN EACH BATHROOM SHALL BE CONTROLLED BY A VACANCY SENSOR. LIGHTING IN GARAGES, LAUNDRY ROOMS, CLOSETS, AND UTILITY ROOMS: ALL LIGHTING SHALL BE HIGH EFFICACY AND AT LEAST ONE LIGHT FIXTURE SHALL BE CONTROLLED BY A VACANCY SENSOR

PERMANENTY INSTALLED LIGHTS IN ROOMS OTHER THAN BATHROOMS, GARAGES. LAUNDRY ROOMS, AND UTILITY ROOMS SHALL BE HIGH EFFICACY LUMINAIRES. LUMINAIRES RECESSED INTO INSULATED CEILINGS SHALL NOT CONTAIN SCREW BASE

SOCKETS AND SHALL BE APPROVED FOR ZERO CLEARANCE INSULATION COVER (IC) BY U. OR OTHER TESTING LAB RECOGNIZED BY BUILDING OFFICIAL, AND SHALL BE CERTIFIED AIR TIGHT TO SHOW AIR LEAKAGE LESS THAN 2.0 CFM AT .011 PSI IN ACCORDANCE WITH ASTM E283 AND SEALED WITH A GASKET OR CAULK BETWEEN THE HOUSING AND CEILING. SCREW BASE SOCKETS SHALL MEET THE FOLLOWING REQUIREMENTS:

 THE LUMINAIRE SHALL CONTAIN LAMPS THAT COMPLY WITH REFERENCE JOINT APPENDIX JA8 AND;

• THE LUMINAIRE SHALL NOT BE A RECESSED DOWNLIGHT IN A CEILING AND;

THE INSTALLED LAMPS SHALL BE MARKED WITH JA8-2019 OR JA8-2019E AS SPECIFIED REFERENCE JOINT APPENDIX JA8 DIMMERS OR VACANCY SENSORS

#### GENERAL NOTES - FIRE AND SAFETY

SMOKE ALARMS SHALL BE INSTALLED NOT LESS THAN 3 FEET HORIZONTALLY FROM THE

SHALL BE EQUIPPED WITH A BATTERY BACKUP. SMOKE ALARMS SHALL EMIT A SIGNAL

DOOR OF A BATHROOM SECTION R314.3 SMOKE ALARMS SHALL BE INTERCONNECTED IN SUCH MANNER THAT ACTIVATION OF ONE ALARM WILL ACTIVATE ALL OF THE ALARMS IN THE INDIVIDUAL UNIT SECTION R314.4 SMOKE ALARMS SHALL RECEIVE THEIR PRIMARY POWER FROM THE BUILDING WIRING AND

WHEN BATTERIES ARE LOW. CARBON MONOXIDE SHALL BE INTERCONNECTED IN SUCH MANNER THAT ACTIVATION OF ONE ALARM WILL ACTIVATE ALL OF THE ALARMS IN THE INDIVIDUAL UNIT SECTION R315.6

#### GENERAL NOTES - RCP

SEE TYPICAL FIXTURE / ACCESSORY MOUNTING HEIGHT DETAIL FOR MOUNTING HEIGHTS.

LIGHTING FIXTURES IN A SHOWER & WITHIN A BATHTUB AREA & LESS THAN 8 FT ABOVE RIM OF TUB SHALL BE RECESSED AND RATED FOR WET LOCATIONS.

HARDWIRED SMOKE DETECTORS W/ BATTERY BACK-UP ARE REQUIRED IN EACH BEDROOM & IN AREAS LEADING TO BEDROOMS & AT TOP OF STAIRS.

DUCT OPENINGS AND OTHER RELATED AIR DISTRIBUTION OPENINGS SHALL BE COVERED DURING CONSTRUCTION

UNLESS FUNCTIONING AS A COMPONENT OF A WHOLE HOUSE VENTILATION SYSTEM, BATHROOM FANS MUST BE CONTROLLED BY A HUMIDISTAT WHICH SHALL BE READILY ACCESSIBLE, HUMIDISTAT CONTROL SHALL BE CAPABLE OF ADJUSTMENT BETWEEN RELATIVE HUMIDITY RANGES OF 50 TO 80%.

WHOLE HOUSE EXHAUST FAN SHALL HAVE INSULATED LOUVERS OR COVERS WHICH CLOSE WHEN THE FAN IS OFF. COVERS OR LOUVERS SHALL HAVE A MINIMUM INSULATION VALUE

UNLESS IN ACCORDANCE WITH CEC 210.12 (A) EXCEPTION 1,2, OR 3, ALL 120-VOLT, SINGLE PHASE, 15 AND 20 AMPERE BRANCH CIRCUITS SUPPLYING OUTLETS OR DEVICES INSTALLED IN DWELLING UNIT KITCHEN, FAMILY ROOM, DINING ROOMS, LIVING ROOMS, PARLORS, LIBRARIES, DENS. BEDROOMS, SUNROOMS, RECREATION ROOMS, CLOSETS, HALLWAYS. LAUNDRY AREAS, OR SIMILAR ROOMS OR AREAS SHALL BE PROTECTED BY A LISTED ARC FAULT/BRANCH CIRCUIT INTERRUPTER, COMBINATION TYPE, A BRANCH/ FEEDER TYPE, A LISTED SUPPLEMENTAL ARC PROTECTION CIRCUIT BREAKER INSTALLED TO PROVIDE

PROTECTION OF THE BRANCH CIRCUIT. ALL 125-VOLT, 15 AND 20 AMPERE RECEPTACLES IN A DWELLING UNIT SHALL BE LISTED TAMPER-RESISTANT RECEPTACLES. PROVIDE IN NEW AND REMODELED AREAS.

PROVIDE 2 OR MORE 20-AMPERE SMALL APPLIANCE BRANCH CIRCUITS IN KITCHEN, PANTRY, BREAKFAST ROOM OR DINING ROOM PER CEC 210.52(B)

PROVIDE A MINIMUM OF ONE 20-AMPERE BRANCH CIRCUIT FOR LAUNDRY RECEPTACLES PER CEC 210.52(F) FOR BATHROOMS, OUTLETS SHALL BE SUPPLIED BY AT LEAST ONE 20-AMPERE BRANCH

CIRCUIT. SUCH CIRCUITS SHALL HAVE NO OTHER OUTLETS. CEC 210.11(C)(3) AT LEAST ONE WALL-SWITCH CONTROLLED LIGHTING OUTLET SHALL BE INSTALLED AT THE EXTERIOR SIDE OF ALL OUTDOOR ENTRANCES OR EXITS AND IN THE GARAGE PER CEC

LIGHTING FIXTURES IN A SHOWER AND WITHIN THE BATHTUB AREA AND LESS THAN 8FT ABOVE RIM OF TUB SHALL BE RECESSED AND RATED FOR WET LOCATIONS. OUTDOOR GFCI RECEPTACLES TO BE WATERPROOF. LIGHTING FIXTURES IN CLOTHES CLOSETS SHALL BE EITHER A SURFACE-MOUNTED OR

RECESSED FIXTURE. 6" MIN. CLEARANCE REQUIRED HORIZONTALLY AND VERTICALLY FROM COMBUSTIBLE MATERIALS. OUTLETS AT KITCHEN, GARAGE, BATHS, PATIOS, BALCONIES AND LAUNDRY SINKS TO BE

1. FIXTURES AT BATHROOMS TO BE PUT ON VACANCY SENSORS.

2. PROVIDE A 120 VOLT HARD-WIRED, INTERCONNECTED SMOKE ALARM WITH BATTERY BACK-UP IN LOCATIONS SHOWN AT ALL NEW CONSTRUCTION. . OUTDOOR LIGHTING PERMANENTLY MOUNTED TO A SINGLE FAMILY DWELLING OR OTHER BUILDINGS IN THE SAME LOT SHALL BE HIGH EFFICACY AND MUST BE CONTROLLED BY AN

ON/OFF SWITCH THAT DOES NOT OVERRIDE TO ON AS LISTED BELOW. ALSO, THE LIGHTING MUST BE CONTROLLED BY A PHOTOCELL AND AUTOMATIC TIME SWITCH CONTROL. CONTROLS THAT OVERRIDE TO ON SHALL NOT BE ALLOWED UNLESS THE OVERRIDE AUTOMATICALLY RETURN THE PHOTOCONTROL AND AUTOMATIC TIME SWITCH CONTROL TO ITS NORMAL OPERATION WITHIN 6 HOURS THE NUMBER OF ELECTRICAL BOXES LOCATED MORE THAN 5 FEET ABOVE FINISHED FLOOR

THAT DO NOT CONTAIN A LUMINAIRE OR OTHER DEVICE SHALL NOT EXCEED THE NUMBER OF BEDROOMS. THESE BOXES MUST BE SERVED BY A DIMMER, VACANCY SENSOR, OR FAN SPEED CONTROL. [CALIFORNIA ENERGY CODE SECTION 150(k) 1 (B)]

ALL VACANCY SENSORS (VS) SHALL BE MANUALLY SWITCHED ON AND AUTOMATICALLY OFF. [CALIFORNIA ENERGY CODE SECTION 150(k) 2 (J)]

GENERAL NOTES:

PROVIDE ALL POWER, LIGHTING AND SIGNAL SYSTEM WORK AND MATERIALS AS SHOWN ON HE DRAWINGS, AS CALLED FOR HEREIN, AND AS IS FURNISH A COMPLETE INSTALLATION.

HE INSTALLATION SHALL CONFORM WITH ALL THE REQUIREMENTS OF THE CURRENT NATIONAL ELECTRICAL CODE, STATE OF CALIFORNIA TITLE 24, ALL APPLICABLE CODES AND ORDINANCES AND THE REQUIREMENTS OF THE FIRE MARSHALL. ALL EQUIPMENT AND WIRING SHALL BEAR THE APPROVAL STAMP OF THE UNDERWRITERS LABORATORY (UL) OR AN APPROVED TESTING LABORATORY. PAYMENT FOR ALL PERMITS AND INSPECTION FEES IS PART OF THIS CONTRACT.

THE RESPONSIBILITY FOR THE SAFETY AND GOOD CONDITION OF ALL MATERIALS AND EQUIPMENT FOR THE ENTIRE INSTALLATION, UNIT COMPLETION OF WORK, SHALL BE INCLUDED WITH THE WORK OF THIS CONTRACT. ERECT AND MAINTAIN APPROVED AND SUITABLE BARRIERS, PROTECTIVE DEVICES AND WARNING SIGNS AND BE FULLY RESPONSIBLE FOR ANY LOSS OR INJURY TO PERSONS OR PROPERTY RESULTING FROM NEGLECTS IN MAINTAINING AND/OR ENFORCING ALL SAFETY PRECAUTIONS AND WARNINGS.

COORDINATE THE ELECTRICAL INSTALLATION WITH ALL OTHER TRADES.

LL TRENCHING, BACKFILLING, CUTTING AND PATCHING SHALL BE PART OF THIS CONTRACT.

FINALIZE ALL ELECTRICAL SERVICE ARRANGEMENTS, INCLUDING VERIFICATION OF LOCATIONS, DETAILS AND COORDINATION OF THE INSTALLATION, AND PAYMENT OF ACCRUED CHARGES VITH LOCAL POWER COMPANY. VERIFY LOCATION OF FACILITIES AND DETAILS WITH POWER. ELEPHONE AND CABLE TELEVISION COMPANIES. IN ADDITION TO REQUIREMENTS SHOWN ON THE DRAWINGS, ETC. WORK SHALL COMPLY WITH CONSTRUCTION STANDARDS AND SERVICE REQUIREMENTS OF RESPECTIVE UTILITIES, INCLUDING ANY SUPPLEMENTAL DRAWINGS ISSUED, SAND SHALL BE SUBJECT TO APPROVAL OF THESE UTILITIES.

RACEWAYS FOR ALL CONDUCTORS SHALL BE TYPE 'EMT' IN ALL CONCEALED AREAS. IN LEXIBLE STEEL CONDUIT MAY BE USED IN CONCEALED AREAS IF A SUITABLE BONDING WIRE IS NSTALLED. UP TO A MAXIMUM LENGTH OF 12'-0". CONCEALED RACEWAYS FOR TELEPHONE AND CATV CABLE WITHIN THE BUILDING SHALL BE CARLON TYPE 'EFT' WITH PULL CORDS INSTALLED IN ALL RUNS. A SUITABLE GROUNDING CONDUCTOR SHALL BE INSTALLED IN ALL CONDUIT RUNS. NOTE THAT THIS CONDUCTOR IS NOT NECESSARILY SHOWN ON THE

XPOSED CONDUITS SHALL ONLY BE ALLOWED WHERE SPECIFICALLY COORDINATED, AND LLOWED BY OWNER/ARCHITECT.

PROVIDE ALL CABLE TV CABLING BACK TO (E) CABLE TV BOX. COORDINATE ALL WORK AND

LOCATIONS IN THE FIELD. CABLE SHALL BE TYPE RG-6/U. PROVIDE ALL TELEPHONE/DATA WIRING. TELEPHONE/DATA WIRING SHALL BE CATEGORY FIVE.

OUTLET AND JUNCTION BOXES SHALL BE 4" SQUARE BY 1 1/2" DEEP, OR LARGER, GALVANIZED

OUTLET AND JUNCTION BOXES SHALL BE FLUSH MOUNTED IN ALL FINISHED AREAS AND SHALL NCLUDE A PLASTER RING SUITABLE FOR THE DEVICE MOUNTED IN THE BOX.

LL WIRING SHALL BE COPPER, INSULATION FOR BRANCH CIRCUIT CONDUCTORS SHALL BE TYPE 'THHN'. IN AREAS WHERE CONDUCTORS MAY BE EXPOSED TO WATER, CONDUCTORS SHALL BE 'THWN'. CONDUCTORS LARGER THAN #6 AWG MAY BE TYPE 'THW'. PROVIDE BRANCH CIRCUIT WIRING, OUTLETS, DEVICES AND CONNECTIONS TO ALL EQUIPMENT.

STEEL LIQUID-TIGHT FLEXIBLE CONDUITS ARE REQUIRED FOR MOTOR CONNECTIONS, CONNECTIONS TO LIQUID-HANDLING EQUIPMENT, AND CONNECTIONS IN WET OR EXTERIOR

ROVIDE ALL CONDUIT, WIRING, OUTLETS, FUSED NEMA 3R DISCONNECT SWITCHES AND QUIPMENT NECESSARY TO CONNECT MECHANICAL SYSTEMS AND EQUIPMENT. INSTALL JTLETS AND EMPTY CONDUITS FOR LOW VOLTAGE CONTROL EQUIPMENT.

URNISH AND INSTALL ALL LIGHT FIXTURES COMPLETE WITH REQUIRED LAMPS, BALLASTS, MOUNTING TRIMS AND DEVICES. ALL EXISTING FIXTURES TO REMAIN SHALL BE CLEANED, REPAIRED OR REPLACED AS NECESSARY, AND RELAMPED. FIXTURES TO BE SUPPORTED FROM THE BUILDING STRUCTURE IN AN APPROVED MANNER.

LIGHT SWITCHES AND COVER PLATES TO BE SELECTED BY OWNER.

) COPIES OF SUBMITTAL DRAWINGS ARE REQUIRED FOR LIGHT FIXTURES, CONTROL SYSTEMS AND COVER PLATES.

/ISIT THE SITE PRIOR TO BID TO VERIFY EXISTING CONDITIONS AND MAKE ALLOWANCES FOR VARIANCES TO THAT WHICH IS SHOWN.

PROVIDE ALL MATERIALS AND WORK REQUIRED TO LOCATE AND CONNECT TO EXISTING DISTRIBUTION EQUIPMENT. UPDATE EXISTING PANELBOARDS WITH NEW TYPEWRITTEN IRCUIT DIRECTORIES AND FURNISH NEW CIRCUIT BREAKERS AS REQUIRED. RECONNECT ANY BRANCH CIRCUITS INTERRUPTED DURING DEMOLITION THAT ARE TO REMAIN. CIRCUIT DIRECTORIES SHALL INCLUDE WHERE THE PANEL IS FED FROM.

RE-USE OF EXISTING BRANCH CIRCUIT CONDUITS AND WIRING IS ACCEPTABLE IF IN COMPLIANCE WITH NEC AND APPROVED LOCAL AUTHORITIES.

PROVIDE CONDUIT SEALS FOR ALL CONDUITS PENETRATING WEATHERPROOFING OR VEATHERPROOF ENVELOPE, MASTIC SEAL ALL CONDUIT OPENING PENETRATIONS.

PANELBOARDS SHALL BE EQUAL TO SQUARE D TYPE 'QO'.

LL MAIN LOADCENTER CONNECTIONS, TERMINATION, GROUNDING, AND HARDWARE SSEMBLIES SHALL BE CHECKED BY THE EXPERIENCED MAIN LOADCENTER INSTALLER PRIOR. TO ENERGIZATION OF THE MAIN LOADCENTER. EACH CONNECTION POINT OR FASTENER SHALL BE ALIGNED AND TORQUED IN ACCORDANCE WITH MANUFACTURER'S SPECIFICATIONS.

UNLESS SHOWN OTHERWISE, FUSED DISCONNECT SWITCHES SHALL BE PROVIDED WITH LOW-PEAK. DUAL ELEMENT FUSES. SIZED TO EQUIPMENT NAMEPLATE FUSE CURRENT RATING. WITCHES EXPOSED TO WEATHER SHALL BE NEMA 3R TYPE.

ANELBOARDS, TERMINAL CABINETS, SWITCHGEAR, DISCONNECTS AND MISCELLANEOUS ELECTRICAL EQUIPMENT SHALL HAVE LAMINATED WITH LETTERS ON BLACK BACKGROUND,

DESIGN & PLANNING

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SHEET TITLE

LEVEL 1 REFLECTED **CEILING PLAN** 

REVISIONS

PROJECT NAME HERE PROJECT NAME

01/01/2013

DATE DRAWN








OPTION 1 SPAN VIEW OF ENTRY



OPTION 1 SPAN VIEW OF REAR

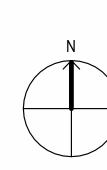

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3D VIEW OF ADU


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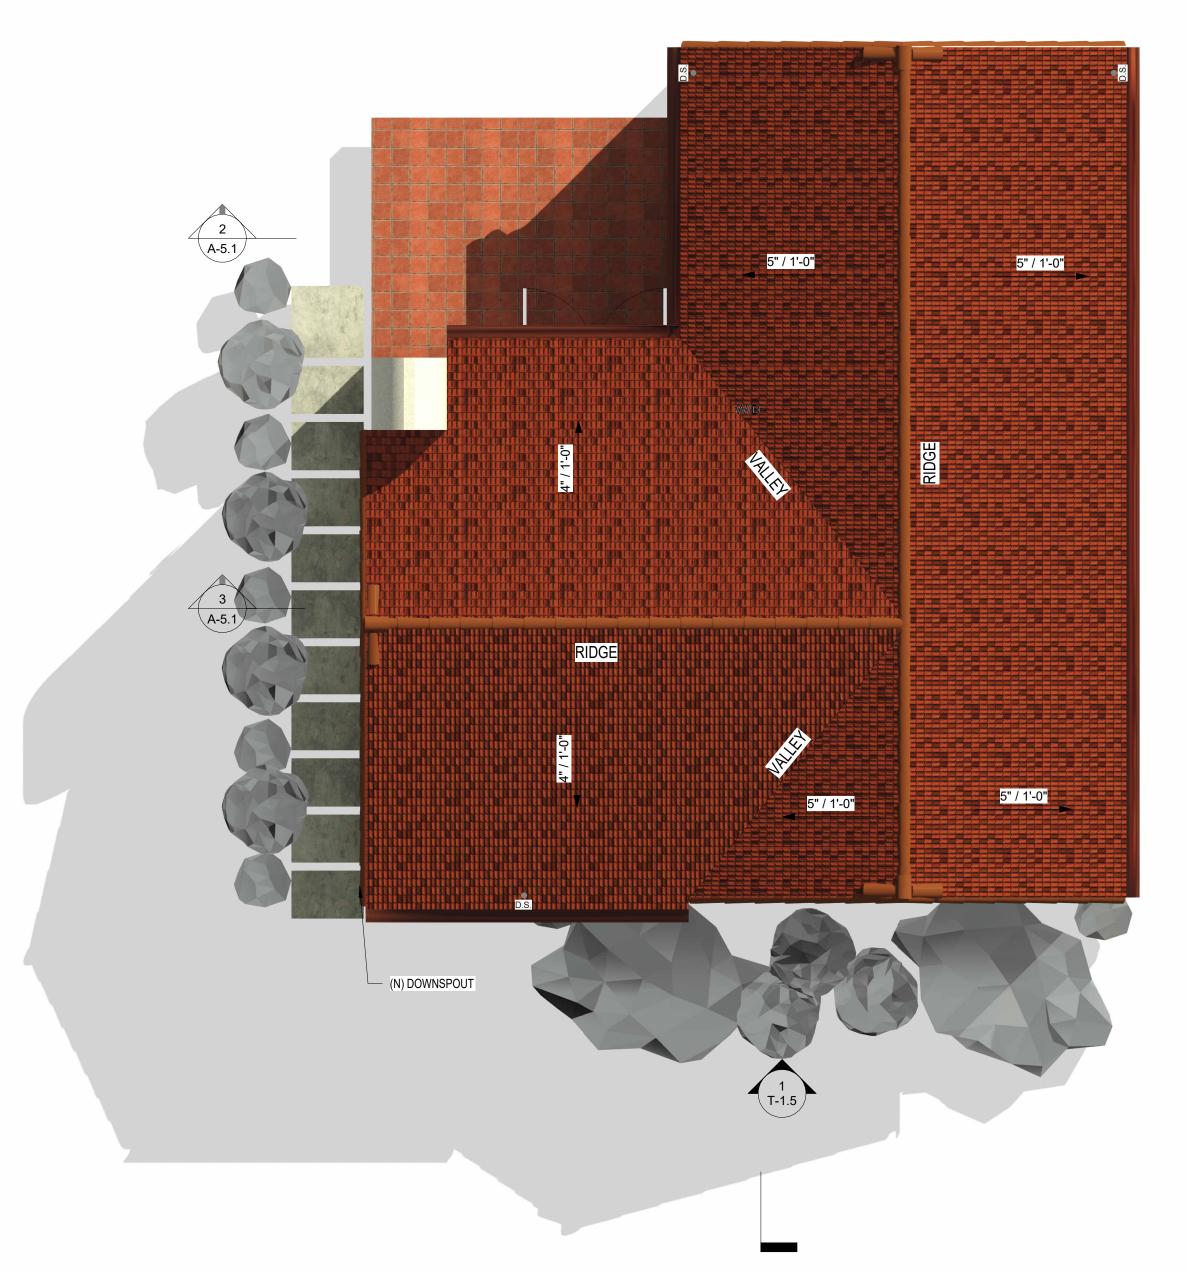
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LEVEL 1 ROOF PLAN SCALE: 1/4" = 1'-0"



#### GENERAL NOTES - ROOF PLAN

CLASS 'A' RATED ROOF OVER ROOFING UNDERLAYMENT. PROVIDE TORCH DOWN MEMBRANE ROOF FOR SLOPES LESS THAN 2:12

ALL ROOF EDGES TO HAVE G.I. DRIP EDGE, PAINTED TO MATCH ADJOINING SURFACES

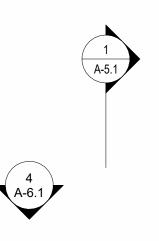ALL EXPOSED CRICKETS & SADDLES TO BE 26 GA. G.I., PAINT TO MATCH ADJOINING

VALLEY FLASHING TO BE 36" WIDE 26 GA. G.I. FLASHING RUN 18" ONTO EACH ROOF PLANE, OVER 36" MIN. WIDE UNDERLAYMENT CONSISTING OF 1-LAYER OF 72# MINERAL SURFACE NON-PERFORMATED CAP SHEEP COMPLYING W/ ASTM D3909 RUNNING THE ENTIRE LENGTH OF THE VALLEY, INSTALLED OVER THE COMBUSTIBLE DECKING PER CRC R327.5.3, AND PAINTED TO MATCH ADJOINING SURFACES

OVERHANG SIZE AS NOTED ON PLAN

ROOF PITCH AS INDICATED ON PLAN

GUTTER GUARDS ARE TO BE PROVIDED AT ALL ROOF GUTTERS TO PREVENT THE ACCUMULATION OF LEAVES AND DEBRIS PER CRC SECTION R327

COORDINATE LOCATION OF ALL VENT RISERS WITH ARCHITECT

COORDINATE ALL REQUIRED ROOF PENETRATIONS AND LOCATIONS WITH ARCHITECT

). ALL ROOFING INSTALLATIONS SHALL BE CONSTRUCTED PER MANUFACTURER'S RECOMMENDATIONS TO RECEIVE MANUFACTURER'S INSTALLATION WARRANTY I. ROOF DRAINS AND OVERFLOW DRAINS, WHERE CONCEALED WITHIN THE CONSTRUCTION OF THE BUILDING, SHALL BE INSTALLED IN ACCORDANCE WITH THE PLUMBING CODE [2019 CBC SECTION 506.4]

2. ALL ATTICS ARE UNVENTILATED. SPRAY FOAM INSULATION IS APPLIED AT THE UNDERSIDE OF ROOF SHEATHING

#### STORMWATER CONTROL NOTES

CONTRACTOR SHALL SCHEDULE STORM DRAIN WORK AHEAD OF OTHER UNDERGROUND CONDUIT CONSTRUCTION. GRAVITY STORM DRAIN WORK SHALL BEGIN AT THE LOWEST POINT OF DISCHARGE AND

PROCEED UPSTREAM. POLYVINYL CHLORIDE (PVC) PIPE FOR 4" THROUGH 15" SIZE SHALL COMPLY WITH THE MOST RECENT ISSUE OF ASTM STANDARD D-3034 (SDR 35). PVC PIPE SHALL HAVE AN INTEGRALLY MOLDED BELL OR SOCKET END FOR GASKETED JOINT ASSEMBLY. JOINTS AND GASKETS SHALL COMPLY WITH THE MOST RECENT ISSUE OF ASTM STANDARD D-3212 AND F-477, RESPECTIVELY. PVC PIPE INSTALLATION SHALL COMPLY WITH UNI-BELL PLASTIC PIPE ASSOCIATION STANDARD UNI-B-5, LATEST REVISION. PVC PIPE CONNECTIONS TO MANHOLES, CATCH BASINS AND OTHER CONCRETE STRUCTURES SHALL BE CONSTRUCTED WITH WATERSTOP AT MIDPOINT OF STRUCTURE WALL PENETRATION. WATERSTOP SHALL BE PVC CONCRETE MANHOLE ADAPTER (4" THROUGH 12" PIPE) OR LARGE DIAMETER WATERSTOP AS MANUFACTURED BY FERNCO, OR EQUIVALENT APPROVED BY THE

HIGH DENSITY POLYETHYLENE (HDPE) PIPE AND FITTINGS FOR 4" THROUGH 48" SIZE SHALL BE N-12PROLINK WT (WATERTIGHT) SERIES AS MANUFACTURED BY ADVANCED DRAINAGE SYSTEMS, INC. (ADS). UNLESS NOTED OTHERWISE. LATERAL CONNECTIONS TO MAINLINES SHALL BE MADE USING MANUFACTURER'S WATERTIGHT REDUCING FITTINGS. PIPE AND FITTING INSTALLATION SHALL BE IN ACCORDANCE WITH MANUFACTURER'S RECOMMENDED PROCEDURES. CONNECTIONS TO CONCRETE STRUCTURES SHALL BE CONSTRUCTED WATERTIGHT USING MANUFACTURER'S RECOMMENDED MATERIALS AND METHODS. GRATED CATCH BASINS SHALL BE CONSTRUCTED IN ACCORDANCE WITH THE PLAN DETAIL

QUALITY REVIEW AND REPORTING MEASUREMENTS.

A. CONTRACTOR SHALL REQUEST INSPECTION BY ENGINEER OF WORK AFTER INSTALLATION AND ASSEMBLY OF STORM DRAINAGE PIPING, BUT BEFORE COVERING. B. CONTRACTOR SHALL REQUEST INSPECTION BY ENGINEER OF WORK AFTER FORMING AND PLACING REINFORCING STEEL FOR CAST-IN-PLACE DRAINAGE STRUCTURES, BUT BEFORE SCHEDULING THE CONCRETE POUR.

C. WITHIN TEN (10) WORKING DAYS OF COMPLETION OF THE STORM DRAIN SYSTEM AND BEFORE CONSTRUCTION OF PAVEMENT, WALKWAYS AND OTHER PERMANENT SURFACE IMPROVEMENTS, CONTRACTOR SHALL PROVIDE A CONSTRUCTION RECORD DRAWING OF THE SYSTEM TO INCLUDE TOP OF GRATE OR COVER AND INLET AND OUTLET INVERT ELEVATIONS OF ALL STORM DRAIN STRUCTURES. ELEVATION MEASUREMENTS SHALL BE ACCURATE TO 0.01 FEET.

D. UPON COMPLETION OF CONSTRUCTION OF THE STORM DRAIN SYSTEM AND WITH 48 HOURS NOTICE TO ENGINEER OF WORK, CONTRACTOR SHALL THOROUGHLY CLEAN AND WASH DOWN ALL INLETS AND STORM DRAIN PIPING USING FIRE HYDRANT FLOWS.

#### KEYNOTES

X.XX KEYNOTE DESIGNATION

**KEYNOTE TEXT** 

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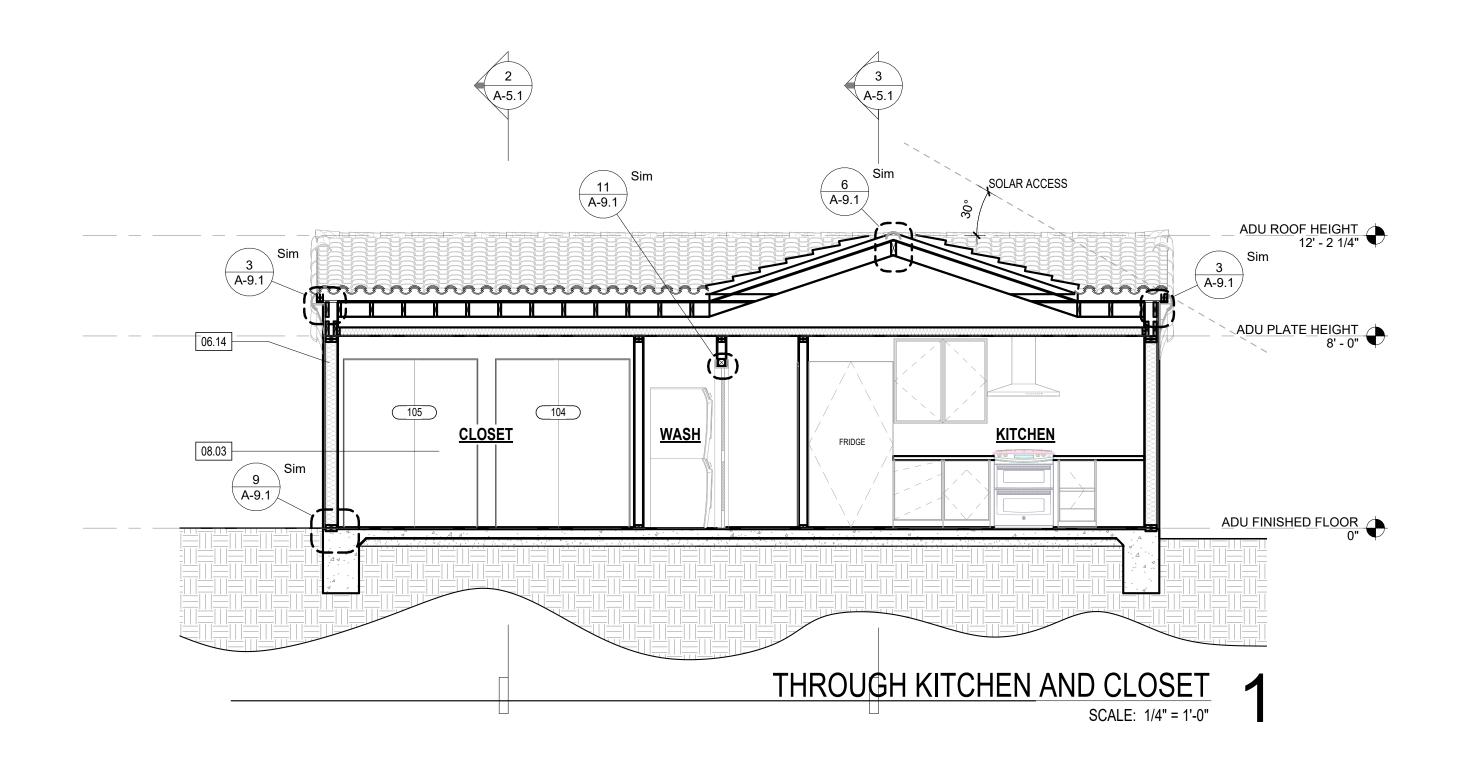
SHEET TITLE **ROOF PLAN** 


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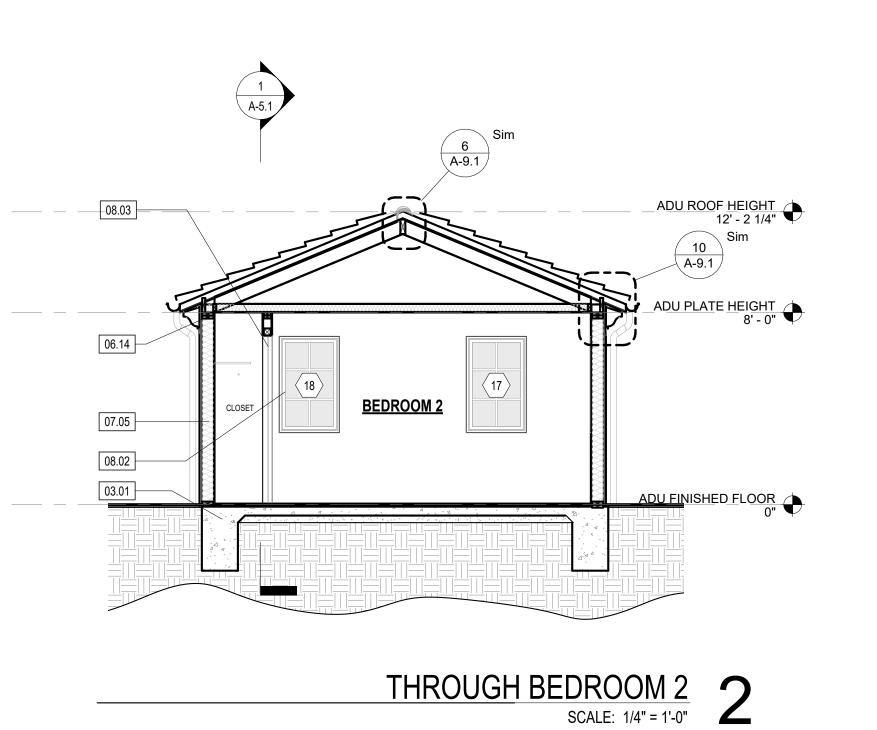
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TAG DESCRIPTION

EX-01 HIGH GRADE / STUCCO / TAN

EX-02 SPANISH SHINGLE / / TERRACOTTA

EX-03 WINDOWS DOORS / ALUM. CLAD / BRONZE

EX-04 PATIO SPACE / CONCRETE / SMOOTH / CONC.

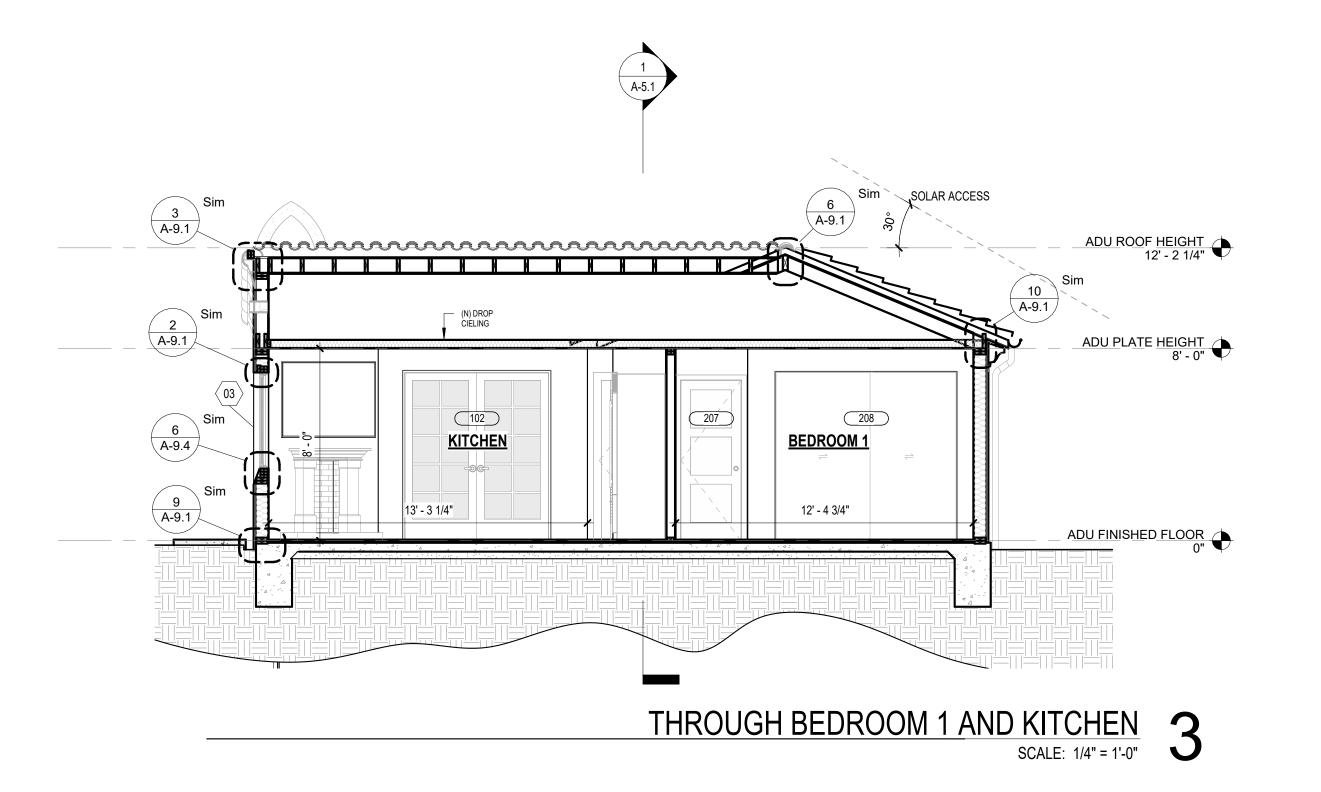EX-05 DESCRIPTION / MATERIAL / TEXTURE / COLOR

EX-06 DESCRIPTION / MATERIAL / TEXTURE / COLOR

# DESIGN & PLANNING Adam Stickels Stickels Contractor 1263 Mead Ave. Ventura Ca. 93004 Cell: 805-616-0664 Email: Adamstickels@gmail.com

KEYNOTES

VALUE

X.XX KEYNOTE DESIGNATION

03.01 CONCRETE DECK PER STRUCT., SLOPE TO EXTERIOR

06.14 2X CEILING FRAMING, SEE STRUCTURAL

07.05 R-38 ICYNENE CLOSED CELL SPRAY FOAM INSULATION PER TITLE-24 AND INSULATION SCHEDULE

**KEYNOTE TEXT** 

08.02 ALUMINUM WINDOW PER SCHEDULE, ALL WINDOWS TO BE NFRC LABELED
 08.03 WOOD INTERIOR DOOR PER SCHEDULE

INSULATION SCHEDULE

PROVIDE THERMAL INSULATION AS SHOWN ON THE DRAWINGS, WITH THE FOLLOWING MINIMUMS:

EXISTING 2X4 EXTERIOR WALLS AND WALLS BETWEEN HEATED AND UNHEATED SPACES: R-13 BATT INSULATION

NEW 2X6 EXTERIOR WALLS AND WALLS BETWEEN HEATED AND UNHEATED SPACES: R-19 BATT INSULATION

ROOF INSULATION:

R-30 CLOSED CELL ICYNENE INSULATION AT UNDERSIDE OF ROOF SHEATHING

INSULATE ALL PIPE & MECHANICAL CHASES FOR SOUND.

PROVIDE ROCK WOOL INSULATION OR EQUIVALENT BETWEEN ALL WINDOW AND EXTERIOR DOOR FRAME AND ROUGH FRAMING.

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**BUILDING SECTIONS** 

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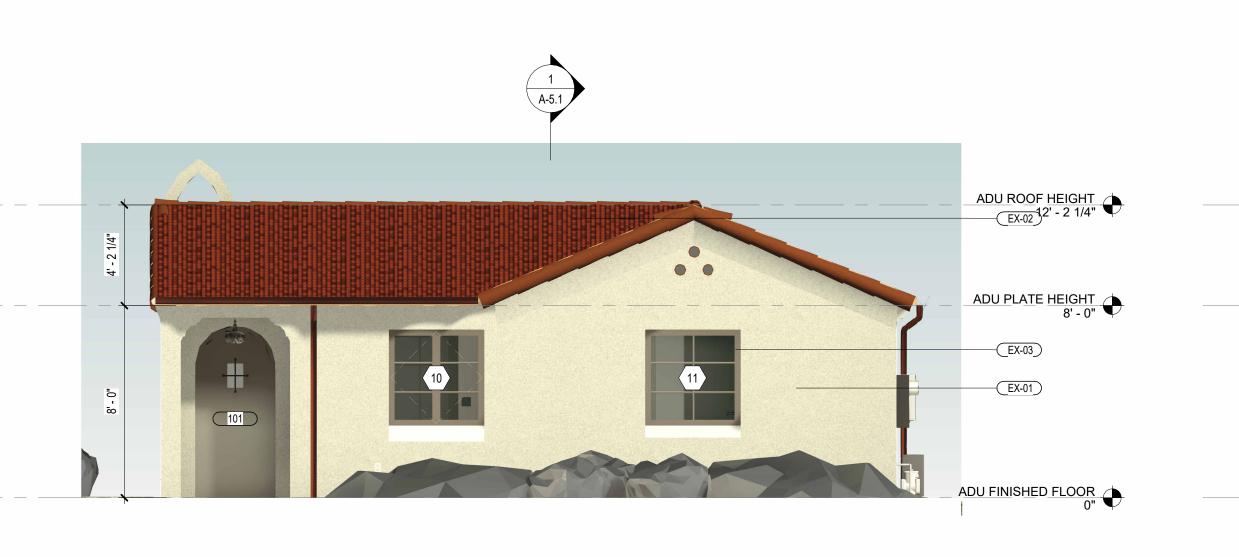
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DATE 01/01/2013

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A-5.1





3 A-5.1

EXTERIOR FINISH & MATERIAL INDEX DESCRIPTION HIGH GRADE / STUCCO / TAN EX-02 SPANISH SHINGLE / / TERRACOTTA EX-03 WINDOWS DOORS / ALUM. CLAD / BRONZE EX-04 PATIO SPACE / CONCRETE / SMOOTH / CONC. DESCRIPTION / MATERIAL / TEXTURE / COLOR DESCRIPTION / MATERIAL / TEXTURE / COLOR DESCRIPTION / MATERIAL / TEXTURE / COLOR

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KEYNOTES

33.01 (N) GAS SUPPLY LINE

X.XX KEYNOTE DESIGNATION

KEY VALUE KEYNOTE TEXT 22.06 TOILETS SHALL BE 1.28 GPF MAX 23.01 NEW CONDENSER ON CONCRETE PAD 26.02 EXTERIOR WALL MOUNTED SCONCE LIGHT, SEE LIGHTING AND ELECTRICAL PLANS, DARK SKY COMPLIANT MODEL APPROVED BY PLANNING DEPARTMENT

CLIENT

CLIENT NAME HERE

PROJECT

PROJECT NAME HERE

SHEET TITLE

PROPOSED **EXTERIOR WITH** CHIMNEY **ELEVATIONS** 

PROJECT ADDRESS HERE

REVISIONS

PROPOSED EAST ELEVATION

PROPOSED NORTH ELEVATION

2 A-5.1

SCALE: 1/4" = 1'-0"

ADU ROOF HEIGHT 12' - 2 1/4"

ADU PLATE HEIGHT 8' - 0"

ADU FINISHED FLOOR

—(EX-02)

EX-03

\_\_\_\_EX-01

SCALE: 1/4" = 1'-0"

PROPOSED WEST ELEVATION SCALE: 1/4" = 1'-0"

PROPOSED SOUTH ELEVATION

PROJECT NAME

PROJECT NAME HERE

DATE DRAWN 01/01/2013

SHEET NO.

A-6.1



SCALE: 1/4" = 1'-0"





NORTH ELEVATION W/O CHIMNEY

EXTERIOR FINISH & MATERIAL INDEX DESCRIPTION HIGH GRADE / STUCCO / TAN EX-02 SPANISH SHINGLE / / TERRACOTTA EX-03 WINDOWS DOORS / ALUM. CLAD / BRONZE EX-04 PATIO SPACE / CONCRETE / SMOOTH / CONC. DESCRIPTION / MATERIAL / TEXTURE / COLOR DESCRIPTION / MATERIAL / TEXTURE / COLOR EX-07 DESCRIPTION / MATERIAL / TEXTURE / COLOR KEYNOTES

KEYNOTE TEXT

X.XX KEYNOTE DESIGNATION

**DESIGN & PLANNING** Adam Stickels Contractor

1263 Mead Ave. Ventura Ca. 93004 Cell: 805-616-0664 Email: Adamstickels@gmail.com

CLIENT

CLIENT NAME HERE

PROJECT

PROJECT NAME HERE

PROJECT ADDRESS HERE

SHEET TITLE

PROPOSED **EXTERIOR WITHOUT** CHIMNEY **ELEVATIONS** 

REVISIONS

SCALE: 1/4" = 1'-0"





WEST ELEVATION W/O CHIMNEY SCALE: 1/4" = 1'-0"


SOUTH ELEVATION W/O CHIMNEY


SCALE: 1/4" = 1'-0"

EAST ELEVATION W/O CHIMNEY SCALE: 1/4" = 1'-0"

> PROJECT NAME HERE PROJECT NAME

DATE DRAWN 01/01/2013

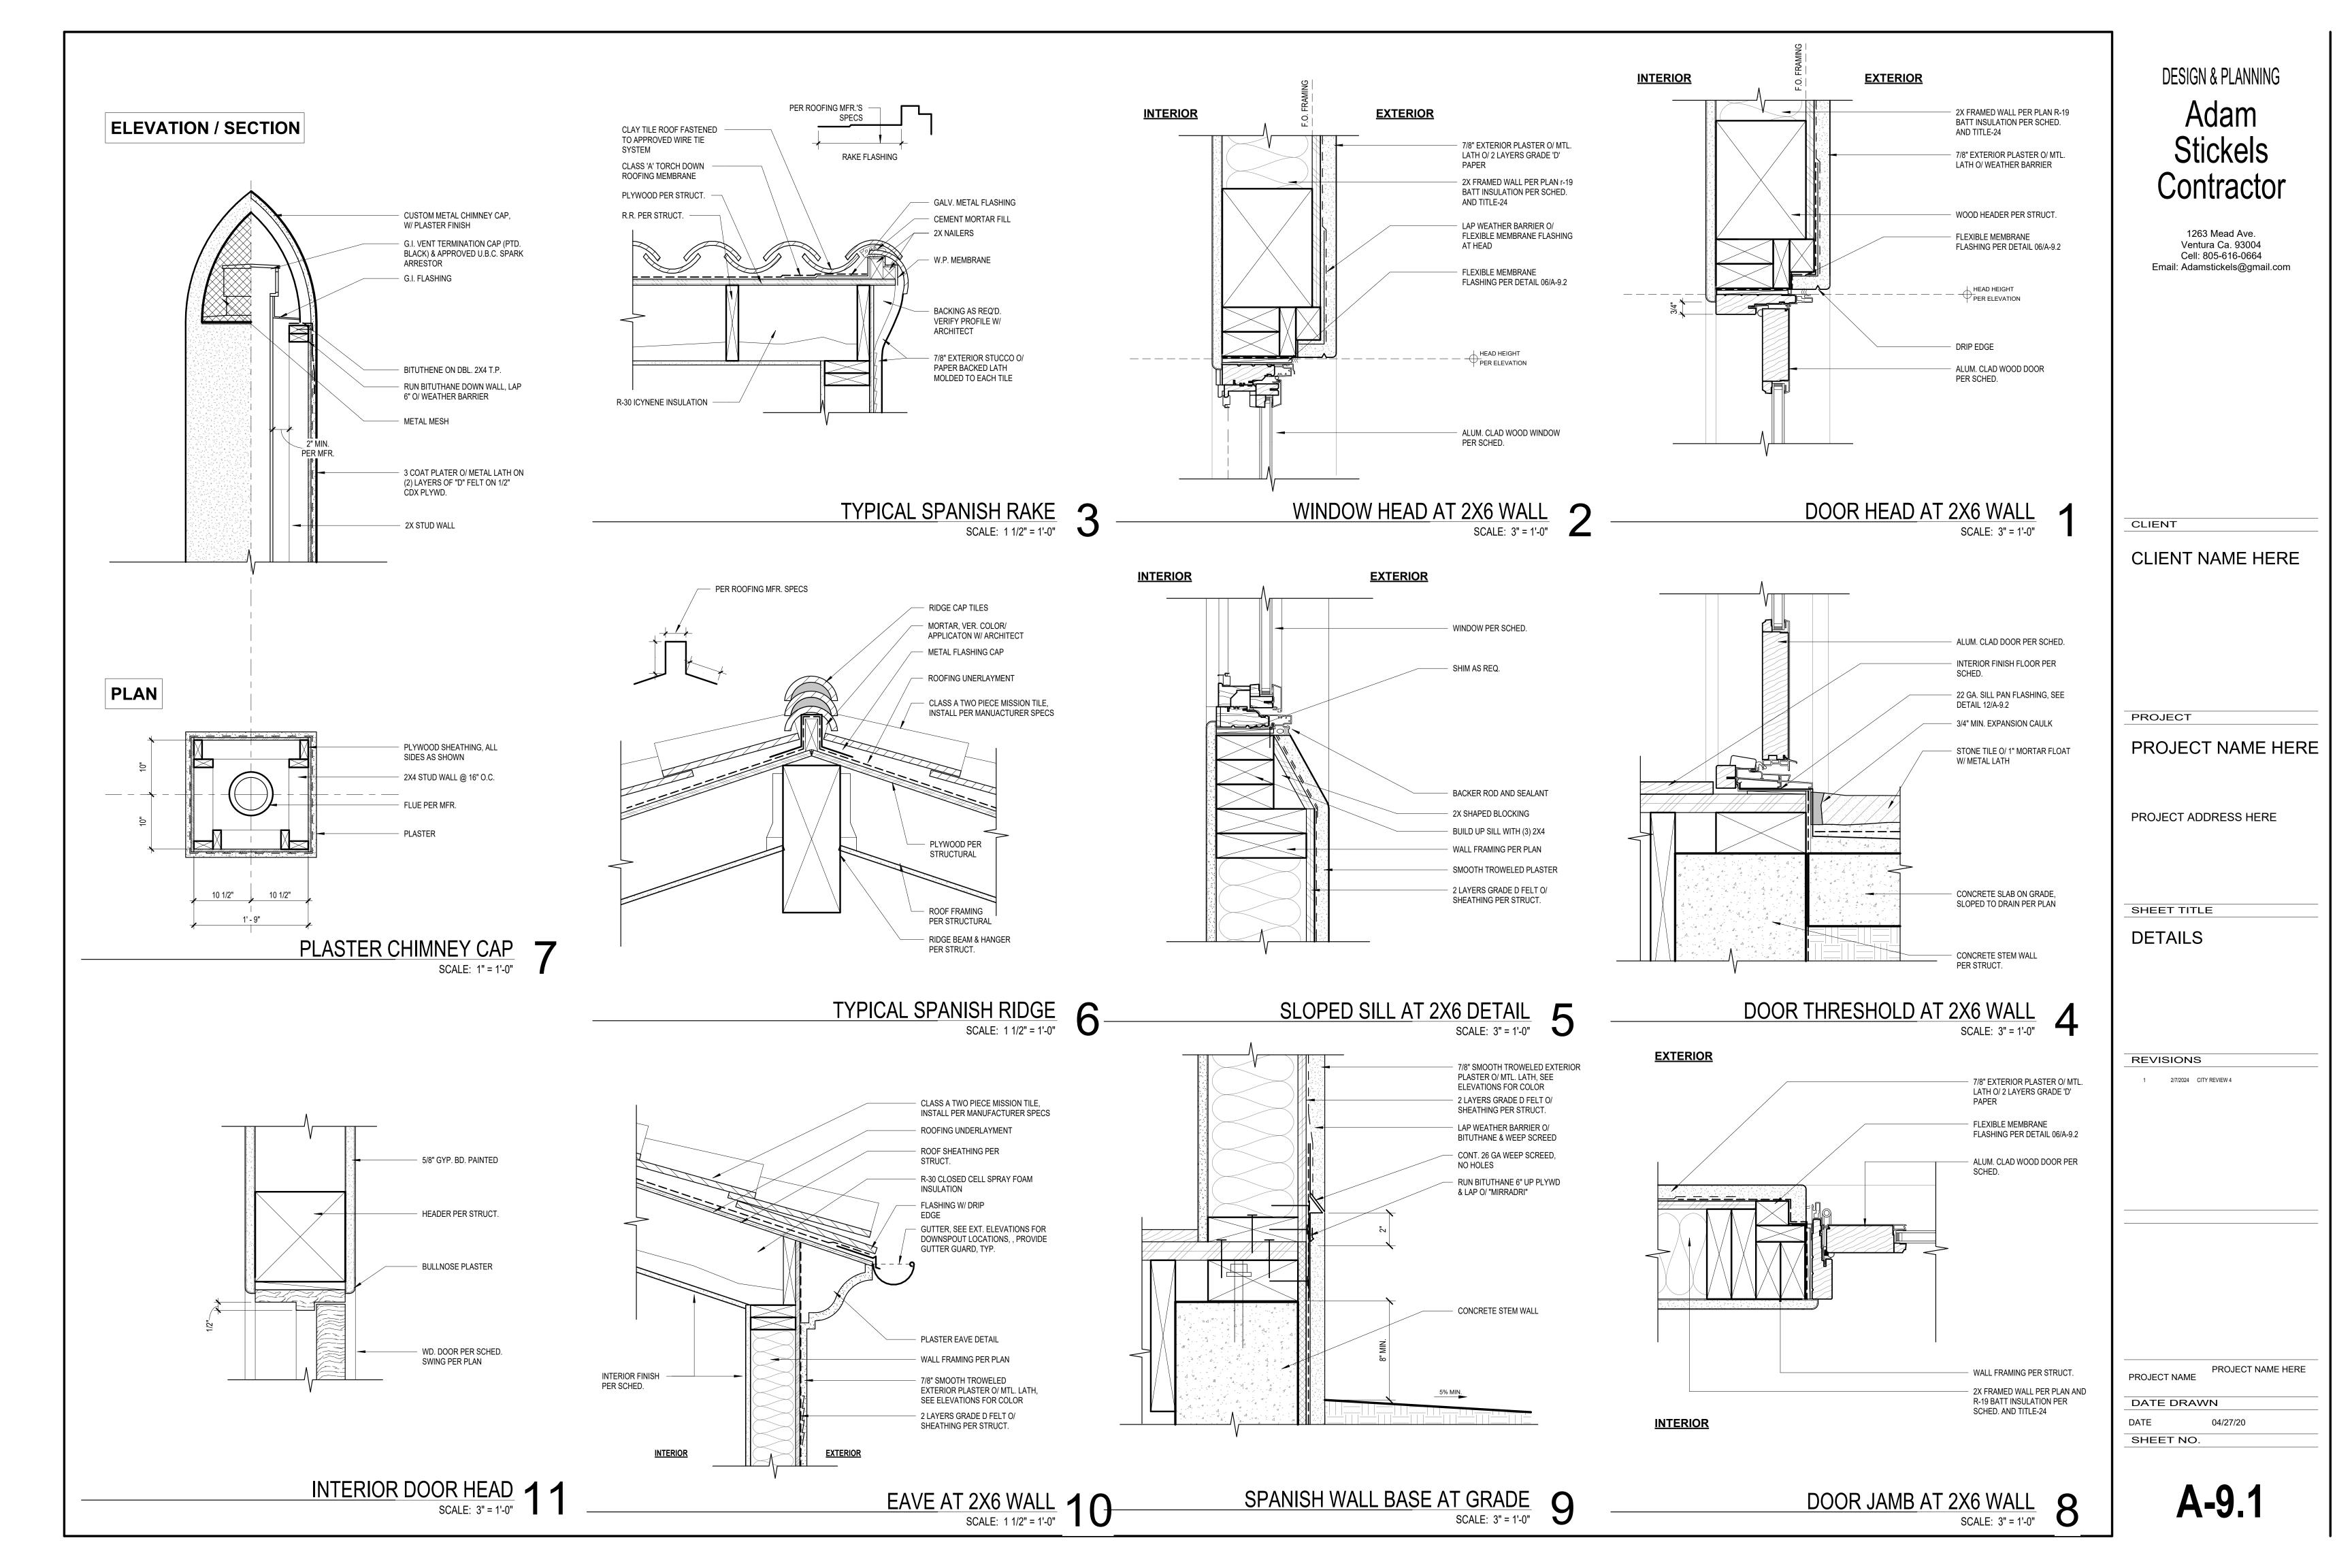

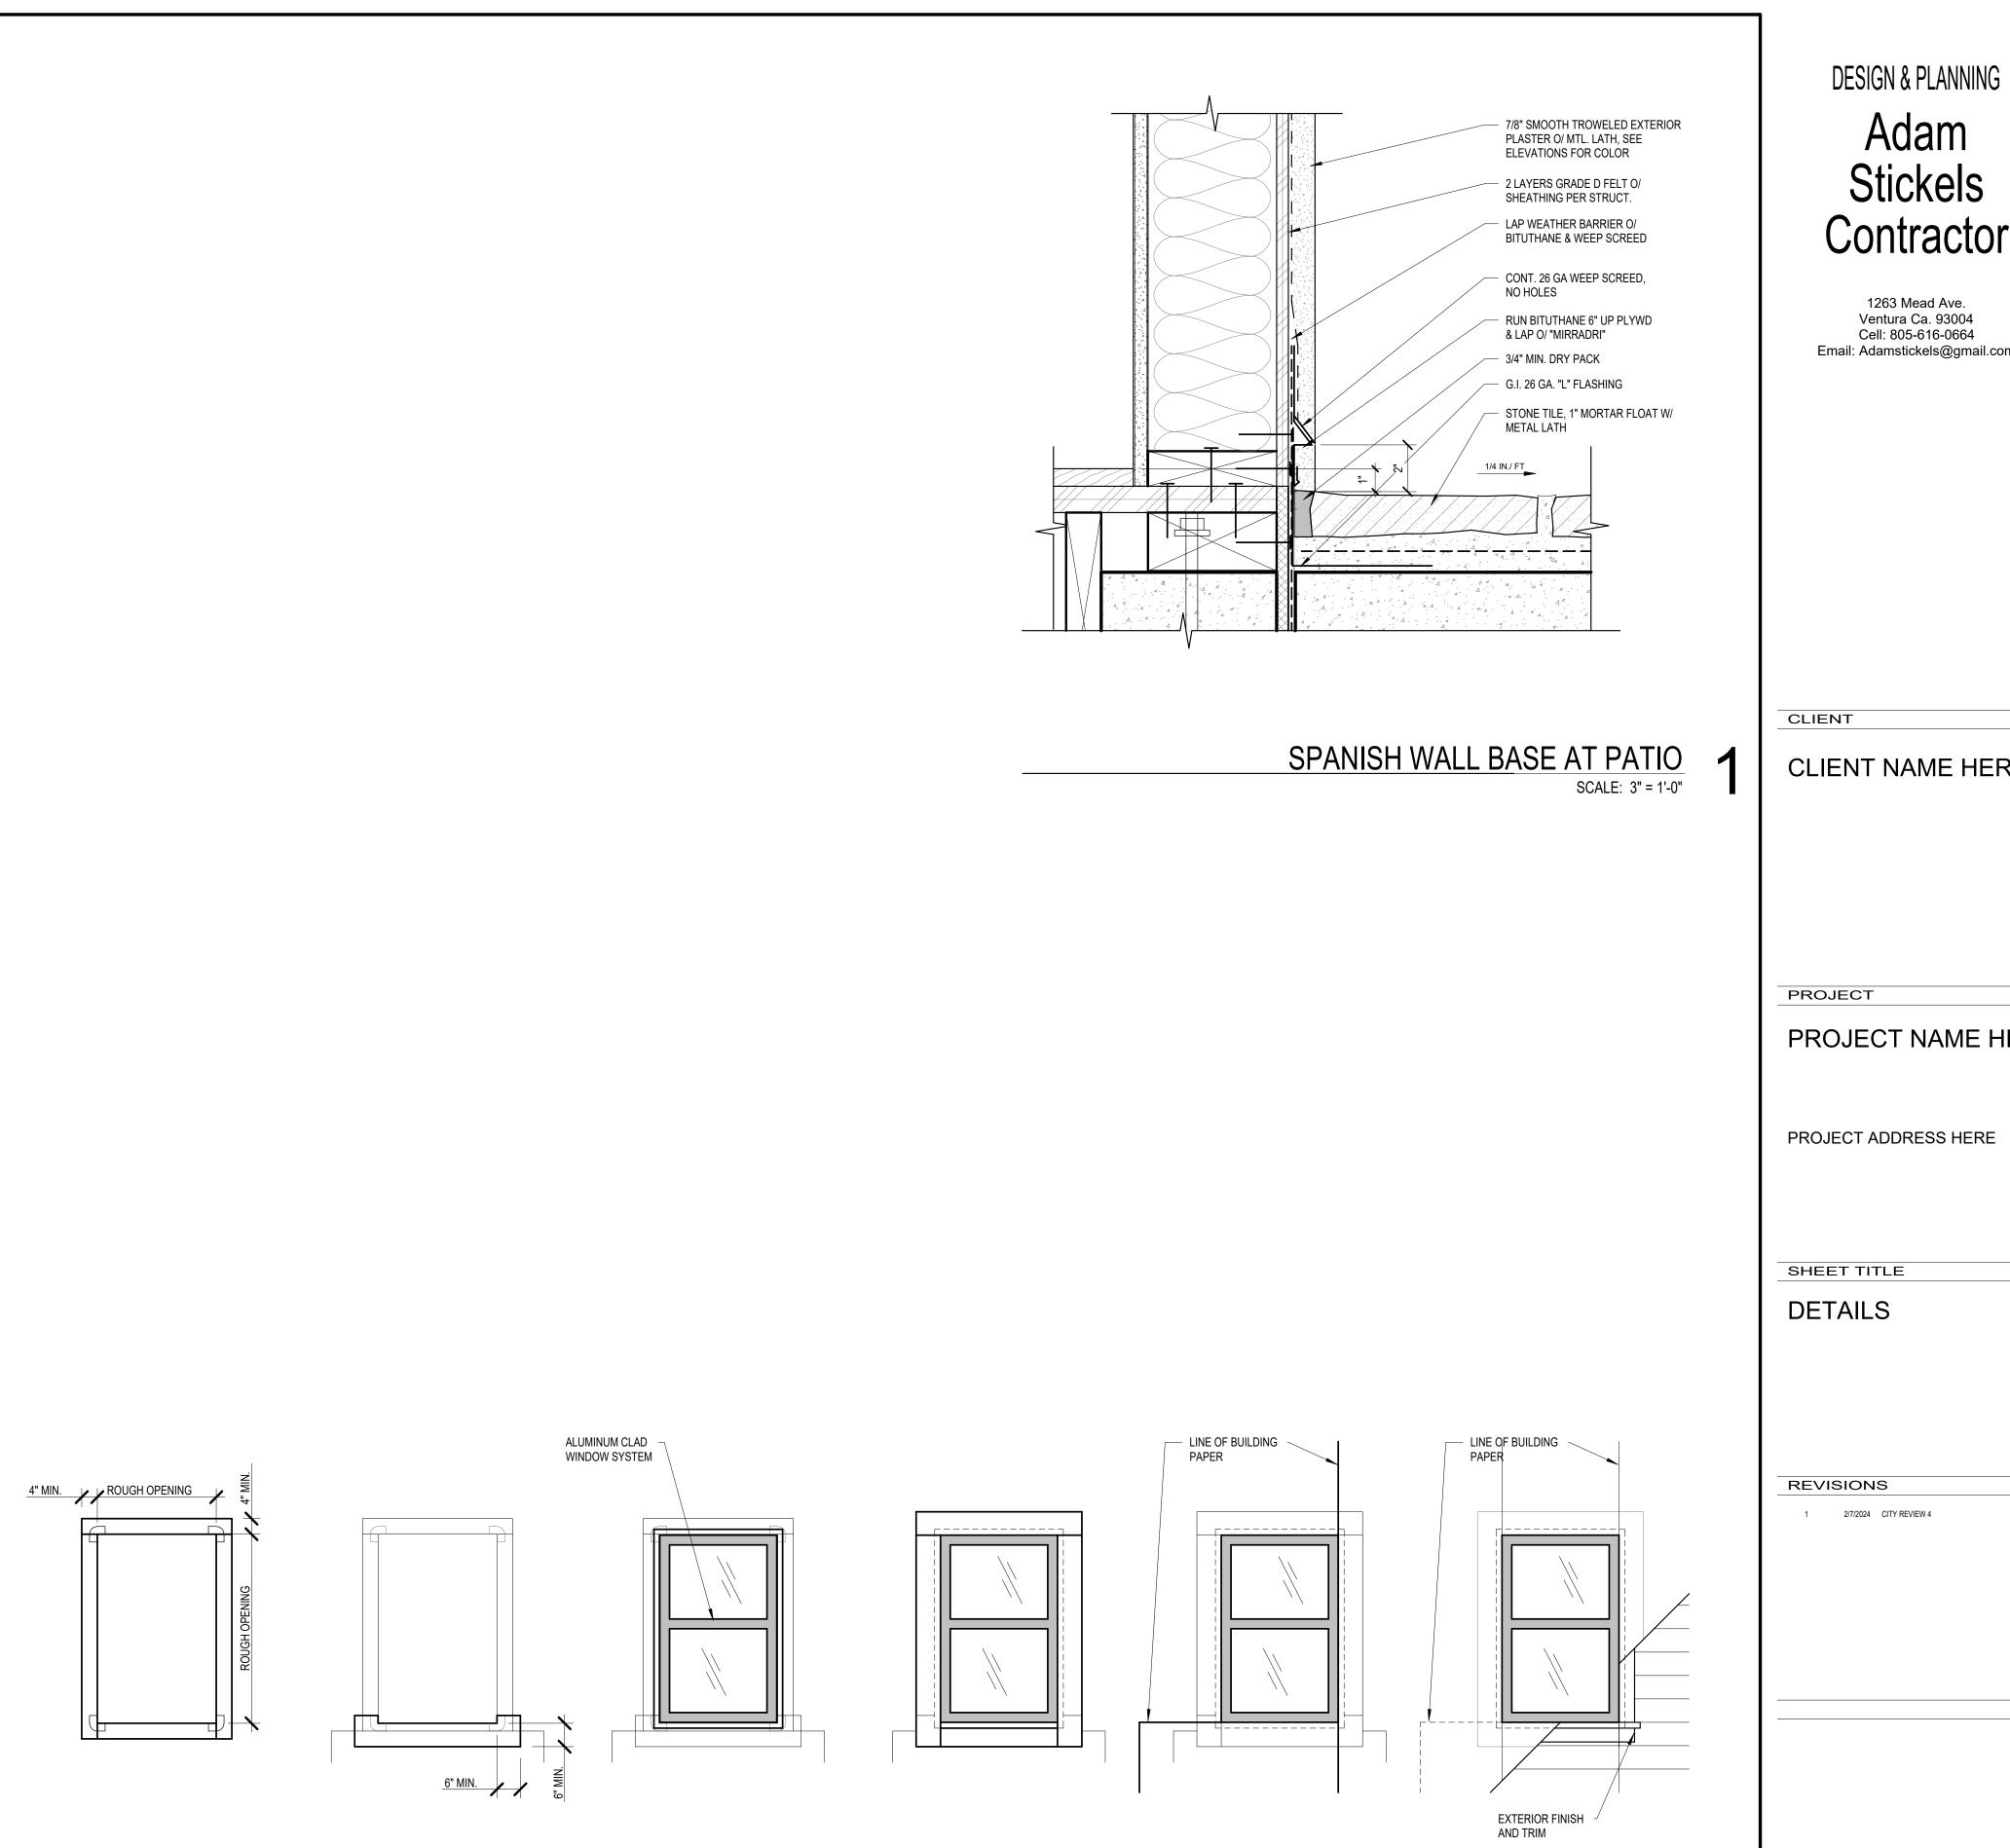

APPLY 20 MIL PEEL AND STICK BUILDING TAPE OVER REMAINING SIDES OF WINDOW FLANGE - 'BT20XL' OR EQUAL, LAP AS SHOWN

APPLY BUILDING PAPER
OVER WINDOW FLANGES
AS SHOWN- MAINTAIN
EXTERIOR SIDE OVERLAP,
TYPICAL

6 APPLY EXTERIOR FINISH AND TRIM PER SCHEDULE

WATER PROOFING FLANGE
SCALE: 3" = 1'-0"

3. INSTALL WINDOW SHIMS AS NECESSARY

INSTALL AND SET WINDOW IN OPENING PER MANUFACTURER'S REQUIREMENTS; MECHANICALLY FASTEN FLANGE TO SUBSTRATE

APPLY BUILDING PAPER AT SILL CONDITION

APPLY 20 MIL PEEL AND STICK BUILDING TAPE AT SILL OVER BUILDING PAPER- 'BT20XL' OR

**EQUAL** 

APPLY 60 MIL PLIABLE
MEMBRANE TAPE OVER
SHEATHING AT CORNERS OF
ROUGH OPENING- 'JS500
DETAIL TAPE OR EQUAL'

SHOWN.

APPLY 40 MIL PEEL AND STICK MEMBRANE AT FRAME - 'P.W. 100/40' OR EQUAL. LAP AS

Adam Stickels Contractor 1263 Mead Ave. Ventura Ca. 93004 Cell: 805-616-0664 Email: Adamstickels@gmail.com CLIENT NAME HERE PROJECT NAME HERE PROJECT ADDRESS HERE 1 2/7/2024 CITY REVIEW 4

> PROJECT NAME HERE PROJECT NAME

DATE DRAWN 04/27/20